

THE CHURCH OF JESUS CHRIST OF LATTER-DAY SAINTS

BLACKFOOT IDAHO WEST STAKE OFFICE RENOVATION

DRAWING INDEX		DRAWING II			DRAWING INDEX
SHEET TITLE	SHEET NUMBER	SHEET TI	TLE	SHEET NUMBER	SHEET TITLE
GENERAL					
ARCHITECTURAL					
EXISTING / DEMO PLAN NEW CONS. & FINISH SCHED.					
DETAILS					
DETAILS					
MECHANICAL					
MECHANICAL FLOOR PLANS, SCHED & DETAILS					
PLUMBING FLOOR PLANS, SCHED & DETAILS					
ELECTRICAL					
ELECTRICAL DETAILS					
ELECTRICAL FLOOR PLANS					
	GENERAL COVER SHEET ARCHITECTURAL EXISTING / DEMO PLAN NEW CONS. & FINISH SCHED. DETAILS DETAILS MECHANICAL MECHANICAL FLOOR PLANS, SCHED & DETAILS PLUMBING FLOOR PLANS, SCHED & DETAILS ELECTRICAL ELECTRICAL ELECTRICAL	GENERAL COVER SHEET ARCHITECTURAL EXISTING / DEMO PLAN NEW CONS. & FINISH SCHED. DETAILS DETAILS MECHANICAL MECHANICAL MECHANICAL FLOOR PLANS, SCHED & DETAILS PLUMBING FLOOR PLANS, SCHED & DETAILS ELECTRICAL ELECTRICAL ELECTRICAL ELECTRICAL DETAILS	GENERAL COVER SHEET ARCHITECTURAL EXISTING / DEMO PLAN NEW CONS. & FINISH SCHED. DETAILS DETAILS DETAILS MECHANICAL MECHANICAL MECHANICAL FLOOR PLANS, SCHED & DETAILS PLUMBING FLOOR PLANS, SCHED & DETAILS ELECTRICAL ELECTRICAL ELECTRICAL DETAILS	GENERAL COVER SHEET ARCHITECTURAL EXISTING / DEMO PLAN NEW CONS. & FINISH SCHED. DETAILS DETAILS DETAILS MECHANICAL MECHANICAL MECHANICAL FLOOR PLANS, SCHED & DETAILS PLUMBING FLOOR PLANS, SCHED & DETAILS ELECTRICAL ELECTRICAL ELECTRICAL ELECTRICAL ELECTRICAL	GENERAL COVER SHEET ARCHITECTURAL EXISTING / DEMO PLAN NEW CONS. & FINISH SCHED. DETAILS DETAILS MECHANICAL MECHANICAL MECHANICAL FLOOR PLANS, SCHED & DETAILS PLUMBING FLOOR PLANS, SCHED & DETAILS ELECTRICAL ELECTRICAL ELECTRICAL ELECTRICAL ELECTRICAL ELECTRICAL OVER SHEET TITLE NUMBER NUMB

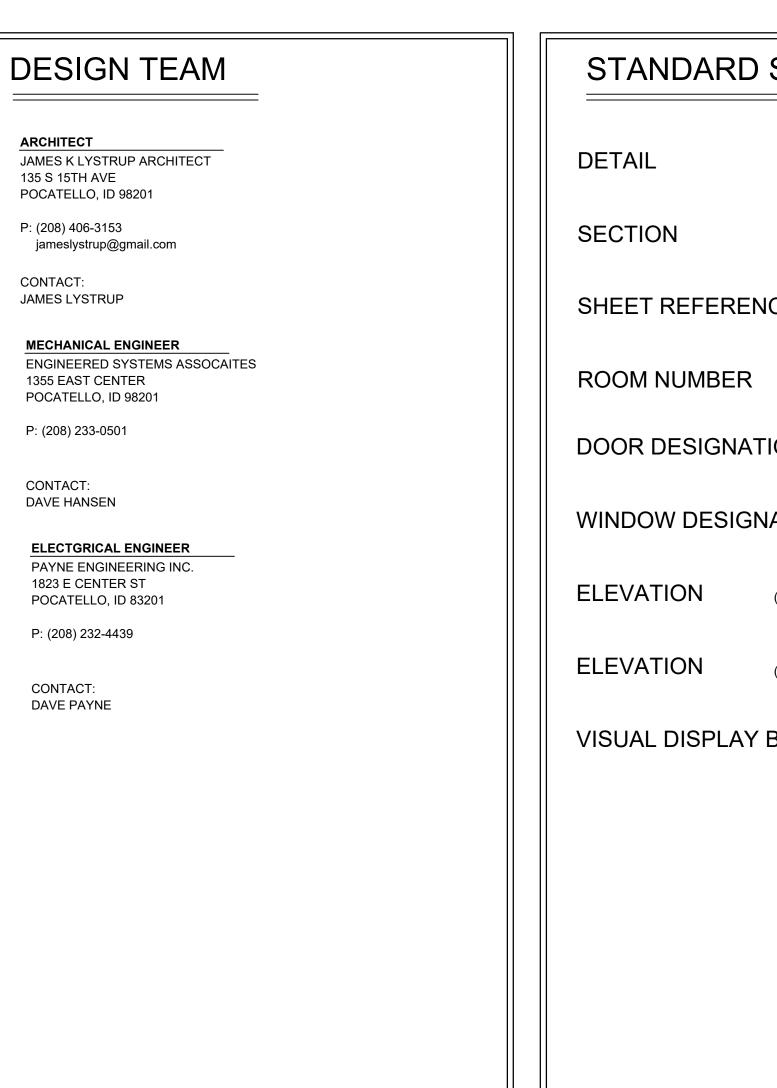

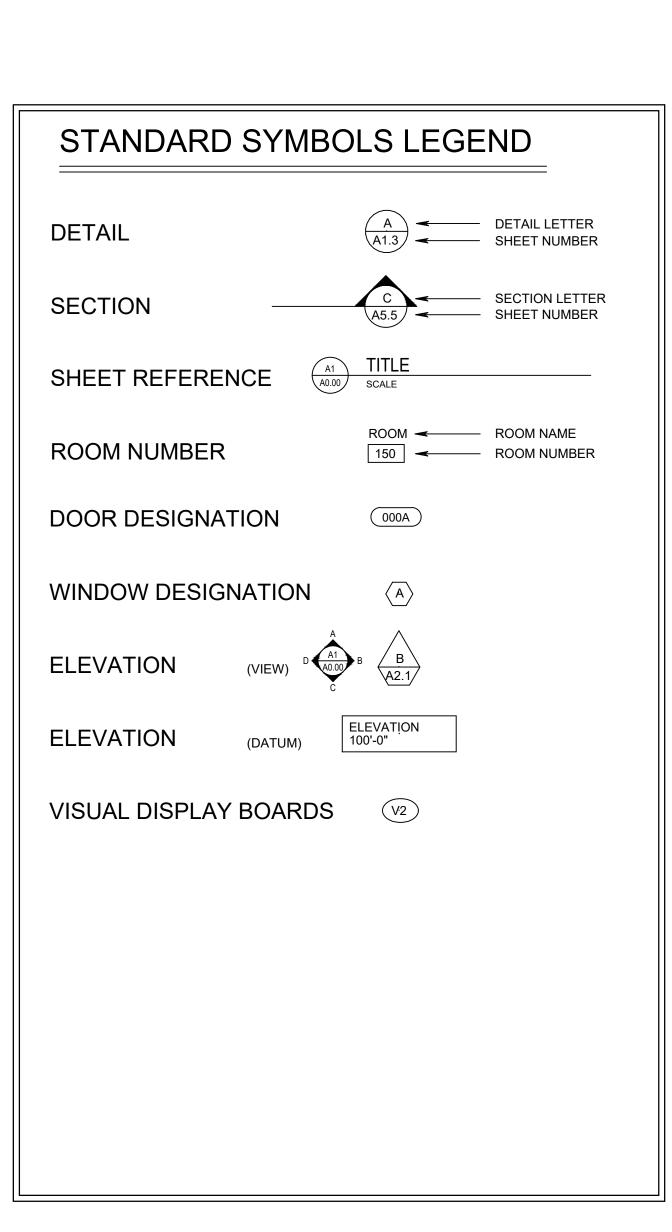



James K. Lystrup
STATE OF IDAHO

WEST STAKE OFFICE
RENOVATION

THE CHURCH OF

JESUS CHRIST
OF LATTER-DAY SAINTS

Pro	Property Number: 513-0220										
Pla	Plan Series:										
Da	Date:										


Date: 2025. 04.08


Sheet Title: COVER SHEET

COVER SHEET INDEX

Sheet:

G1

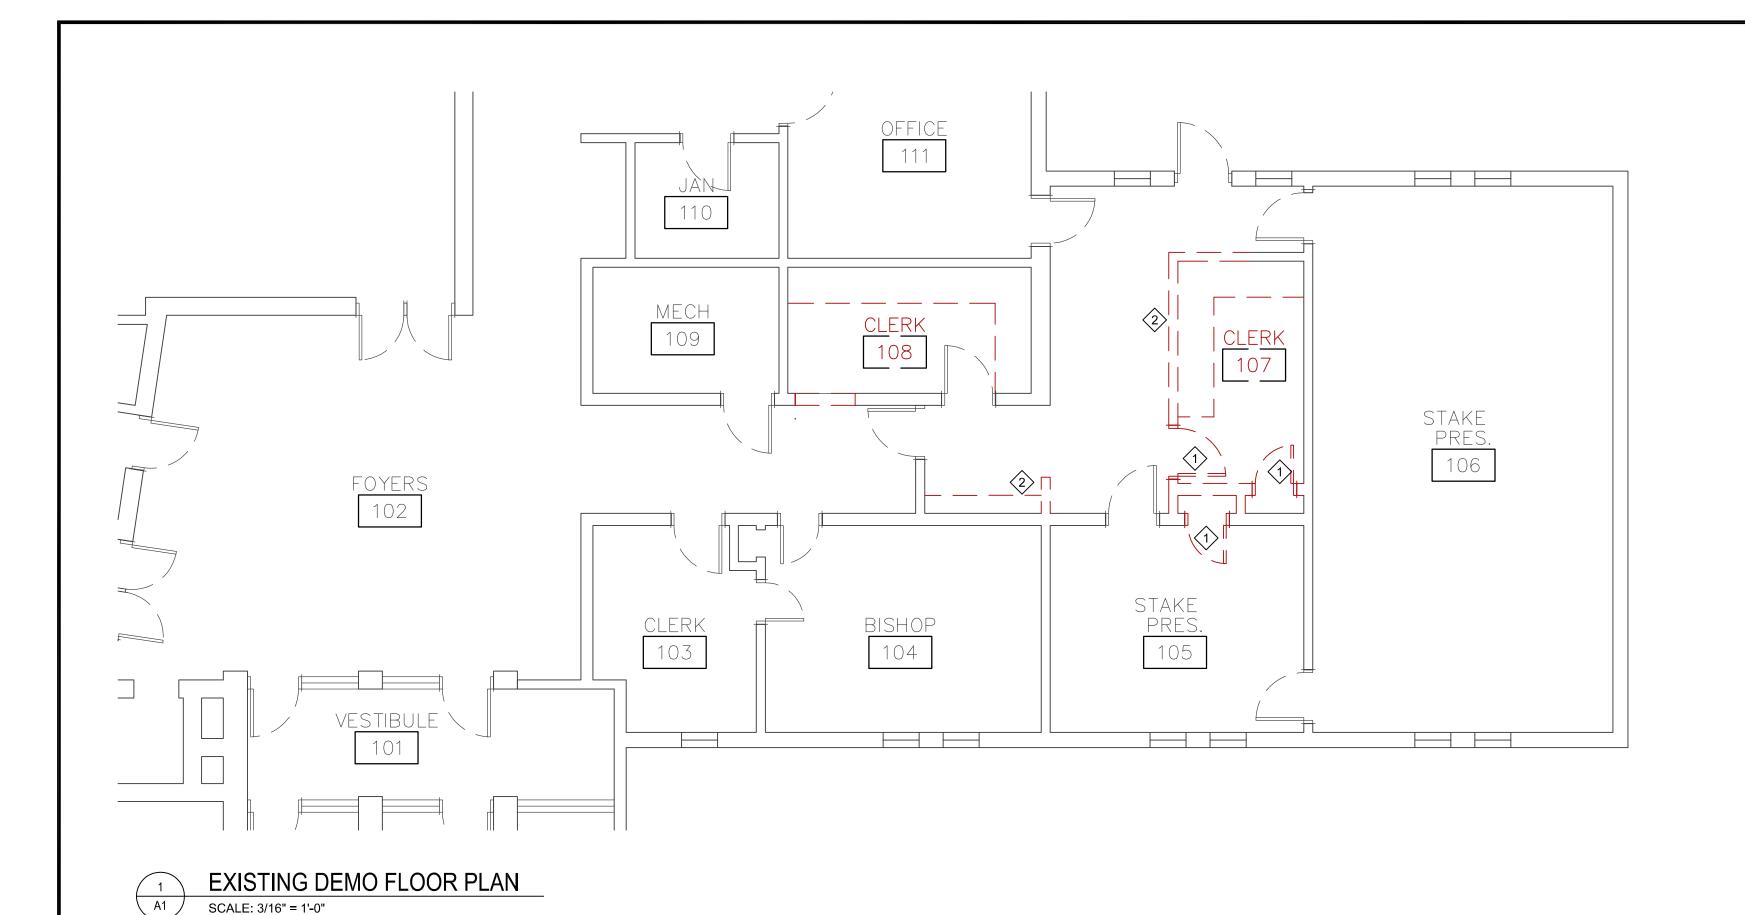

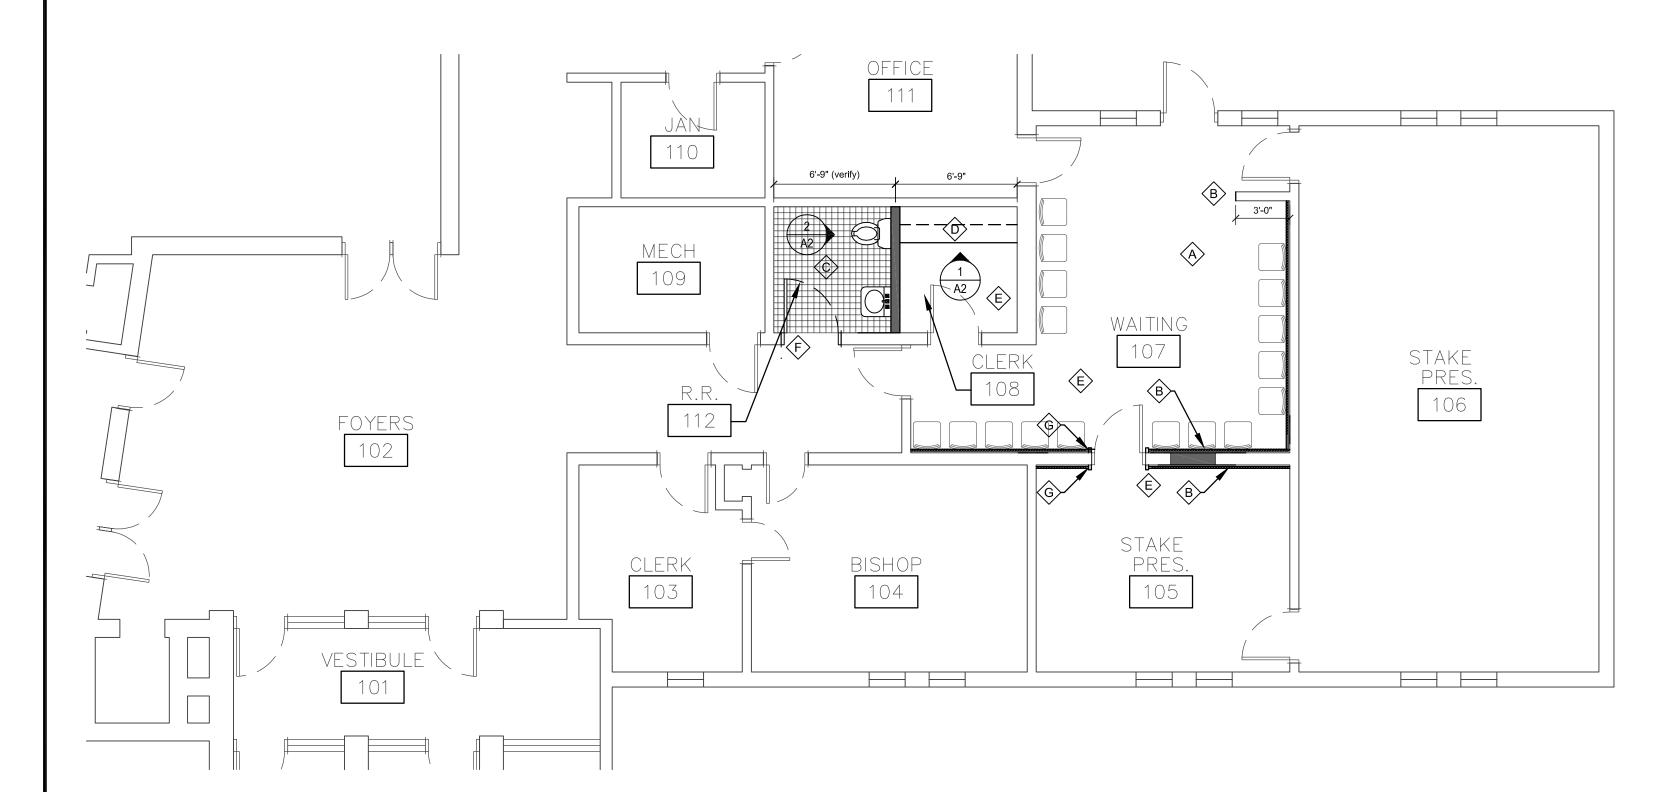

NEW CONSTRUCTION PLAN

SCALE: 3/16" = 1'-0"

DEMO KEY NOTES


- 1 REMOVE EXISTING DOOR AND FRAME
- 2 REMOVE EXISTING WALL
- 3 REMOVE MILLWORK

NEW CONSTRUCTION KEY NOTES

- PATCH EXISTING CEILING GRID AND TILE AS NEEDED AT LOCATION OF WALL REMOVAL.
- B) INFILL WALL CMU WALL OPENING WITH 2X WOOD FRAMING. INSTALL 1/2 GYP BOARD WALLS OVER INTIRE SURFACE OF CMU WALL, FLOAT WALLS WITH MUD, APPLY SISAL WAINSCOT, WOOD CHAIR RAIL AND VINYL WALL COVERING.
- (C) INSTALL NEW THRESHOLDS, FLOOR TILE, WALL TILE, PARTITIONS, FIXTURES, VANITIES, MIRRORS, GRAB BARS AND TISSUE DISPENSER.S
- D INSTALL NEW CASEWORK
- E INSTALL NEW CARPET BASE, CHAIR RAIL, AND WALL COVERING AND PAINT TO MATCH EXISTING
- F) INSTALL NEW 3'-0"x7'-0" SOLID CORE DOOR WITH PAINTED METAL FRAME TO MATCH EXISTING
- (G) INSTALL NEW 1X2 WOOD TRIM AT EXISTING DOOR FRAME

NEW CONSTRUCTION NOTES

- A. CONTRACTOR TO VERIFY ALL DIMENSIONS ON SITE. DIMENSIONS PROVIDED ARE ASSUMED FROM FACE OF GYP BOARD
- B. PROVIDE SOLID BLOCKING IN THE WALLS AT DOOR STOPS, CHALKBOARDS, TACK BOARDS, TOILET COMPARTMENTS, VANITY & BENCH BRACKETS AND OTHER EQUIPMENT AND ACCESSORY LOCATIONS.
- C. WHERE NEW FINISHES ARE INSTALLED OVER EXISTING SURFACES, PROVIDE ADJUSTMENTS IN THICKNESS AS REQUIRED BY EXTENDING ELECTRICAL "J" BOX FOR SWITCHES, OUTLETS, CONTROLS, ETC. EXTEND MECHANICAL DUCTWORK, PIPING, ETC.
- D. PROVIDE STRAIGHT, EVEN FRAMING. CROWN FRAMING SAME DIRECTION LAY 10' STRAIGHT EDGE ON FRAMING & POWER PLANE AS REQUIRED TO REMOVE DISTORTION PRIOR TO INSTALLING FINISH
- E. REVIEW FRAMING CONDITIONS WITH ARCHITECT PRIOR TO INSTALLING FINISH SURFACES.
- F. ADJUST ALL DOOR HEIGHTS AS REQUIRED TO PROVIDE 1/2" CLEARANCE FROM FINISHED FLOOR.

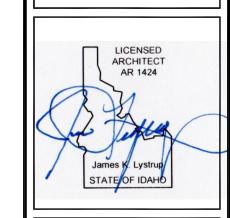

JAMES K.
RCHI

84765 -3153


Malaga L Clara, e (208)

BLACKFOOT IDAHO
WEST STAKE OFFICE
RENOVATION
101 NORTH 900 WEST
BLACKFOOT IDAHO 83221

THE CHURCH OF

JESUS CHRIST

OF LATTER-DAY SAINTS

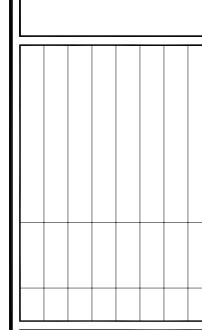

Property Number: 513-0220
Plan Series:

Date: 2025. 04.08

Sheet Title: EXISTING / DEMO PLAN

NEW CONSTRUCTION

FINISH SCHED.

Sheet:

A1

FINISH SCHEDULE WALLS SPECIAL WEST **ROOM NAME** BASE TRIM OR EAST **EQUIPMENT** BASEMENT 005 STAKE PRE. OFFICE S2 - NORTH WALL EX EX 007 WAITING W7 W7 EX EX C3 S2 - SOUTH AND EAST WALL 008 CLERK OFFICE F1 W4 W4 W4 W4 C3 S4 - NORTH WALL 012 REST ROOM F3 B2 W3 W3 W3 W3 C4

DESCRIPTION

F FLOOR

W WALLS

F1 CARPET
F2 WOOD FLOOR SYSTEM

W1 SISAL WALL COVERING
W2 VINYL WALL COVERING

F2 WOOD FLOOR SYSTEM W2 VINYL WALL COVERING
F3 TILE W3 CERAMIC TILE WAINSCOT W/ PAINTED GYPSUM BOARD ABOVE, SEE ELEV.
F4 CONCRETE - PAINTED W4 SISAL WAINSCOT WITH PAINTED GYPSUM BOARD ABOVE

F5 3/4" SHEATHING - PAINTED W5 GYPSUM BOARD - PAINTED
F6 CARPET TILE W6 GYPSUM BOARD - TAPED - NOT PAINTED
F7 VCT TILE W7 SISAL WAINSCOT WITH VINYL WALL COVERING ABOVE,

CEILING

ACOUSTIC TILE ON GYPSUM BOARD

ACOUSTICAL TILE

CEILING SUSPENSION SYSTEM WITH GYPSUM BOARD AND

GYPSUM BOARD - SKIP TROWEL FINISH - PAINTED


CEILING SUSPENSION SYSTEM WITH GYPSUM BOARD - PAINTED

BASE C

- B1 CARPET C1
 B2 COVED TILE
 B3 4" RUBBER C2
 B4 NONE C3
- B4 NONE C3
 B5 METAL ANGLE C4
 C5
- B6 CERAMIC TILE C5 GYPSUM BOARD PAINTED C6 GYPSUM BOARD TAPED NOT PAINTED C7 GYPSUM BOARD
- S SPECIAL TRIM OR EQUIPMENT
- S1 WOOD TRIM S2 CHAIR RAIL
- S3 CABINETS

OTHER

EX EXISTING TO REMAIN

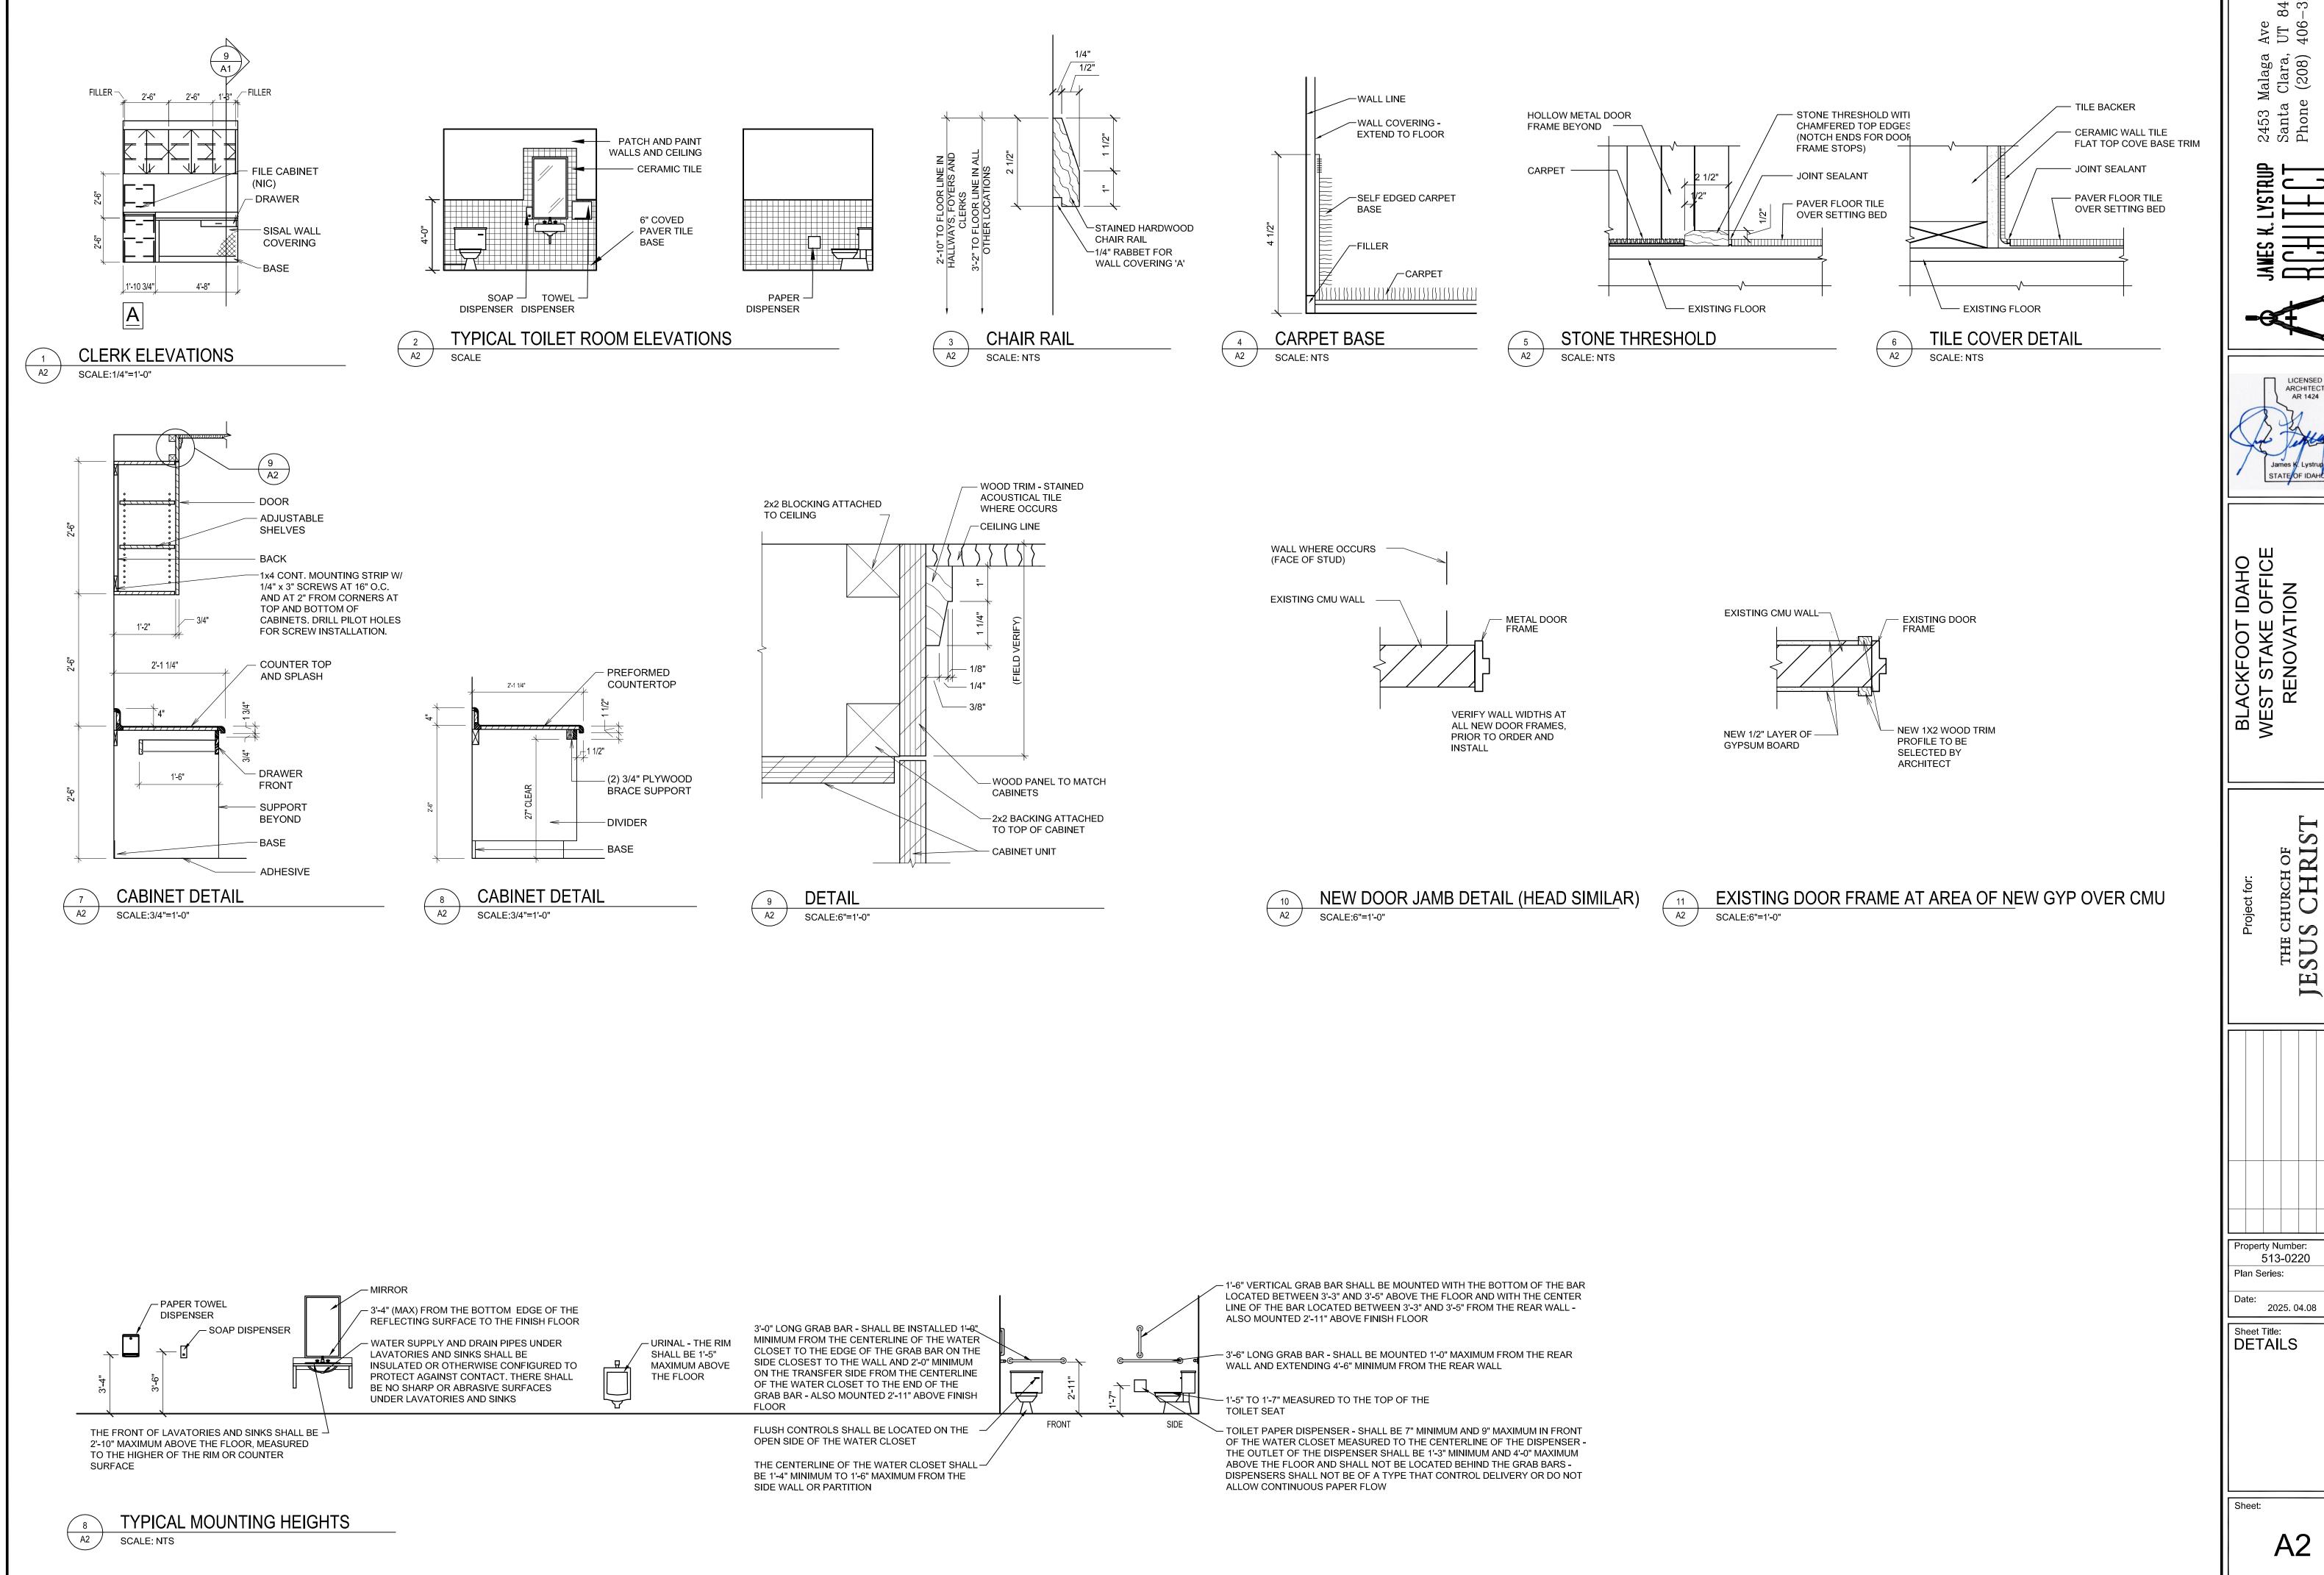


84765 -3153


LICENSED ARCHITECT AR 1424

513-0220


GRILLE AND REGISTER SCHEDULE										
SYM.	TYPE	SIZE	CFM RANGE	THROW PATTERN	CONSTR.	FINISH	BALANCING DAMPER	MAX NC RATING	REMARKS	
CD-1 CFM	CEILING	6x6	50-100	2 WAY CORNER	STEEL	WHITE	NO	20	PRICE MODEL SMD IN BEVELED FRAME	

EXHAUST FAN SCHEDULE										
SYM.	TYPE	C.F.M.	S.P.E.	WATTS	WEIGHT	CHAR.	R.P.M.	CONTROL	REMARKS	
(EF)	CEILING MOUNTED	70	0.25	26.9	N/A	120/60/1	840	WITH LIGHTS SEE ELEC.	TWIN CITY T080E WITH EXHAUST DUCT TO ROOF CAP.	

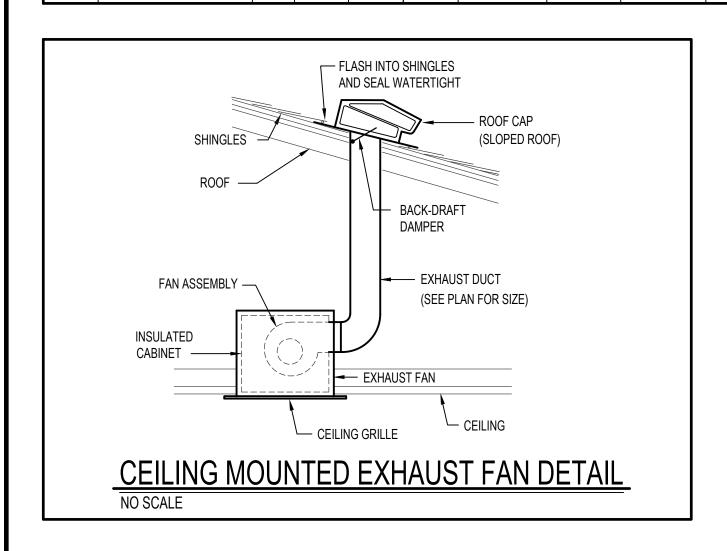


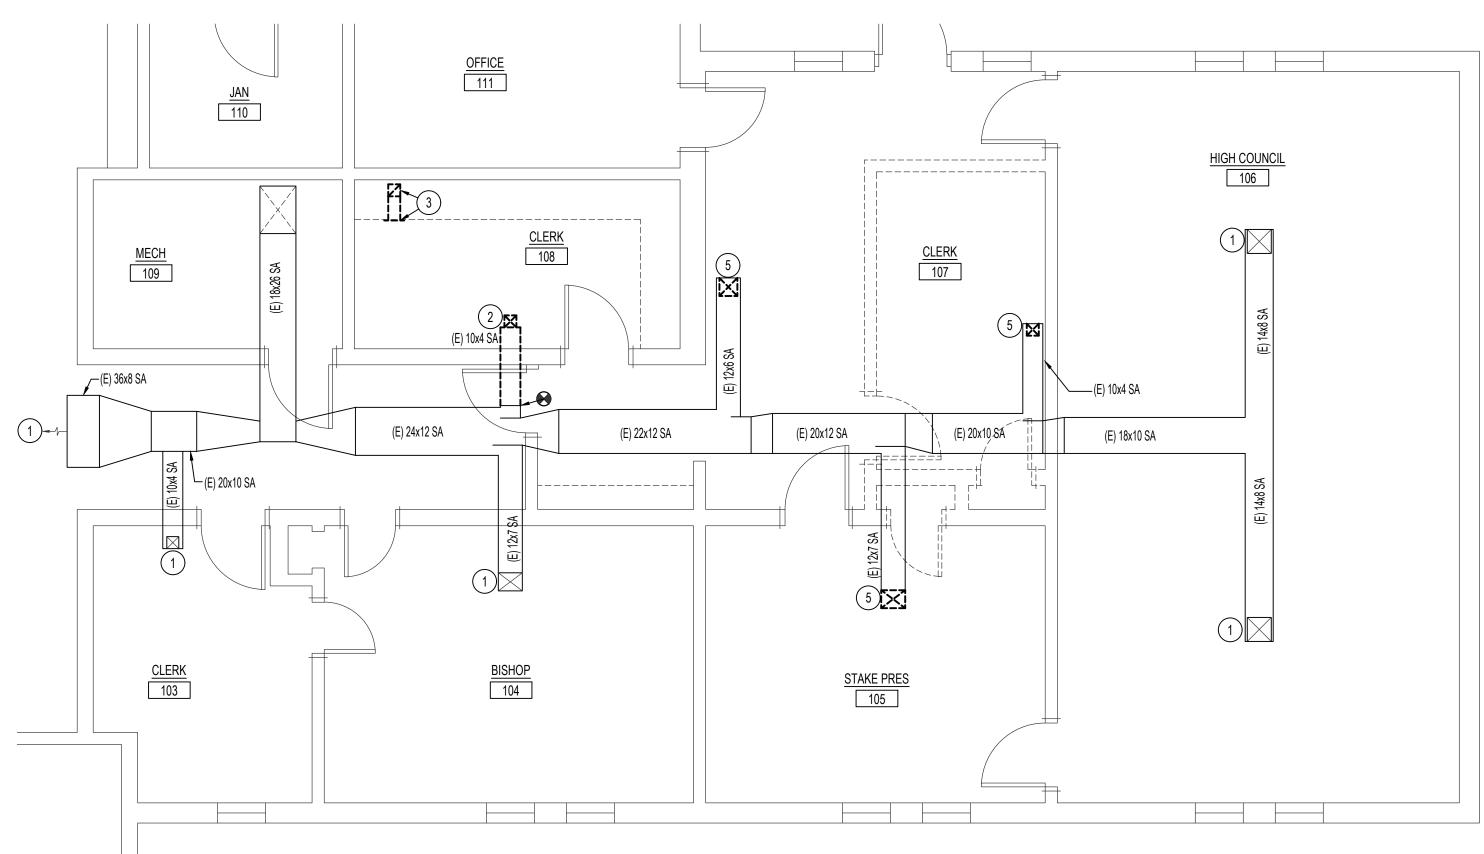



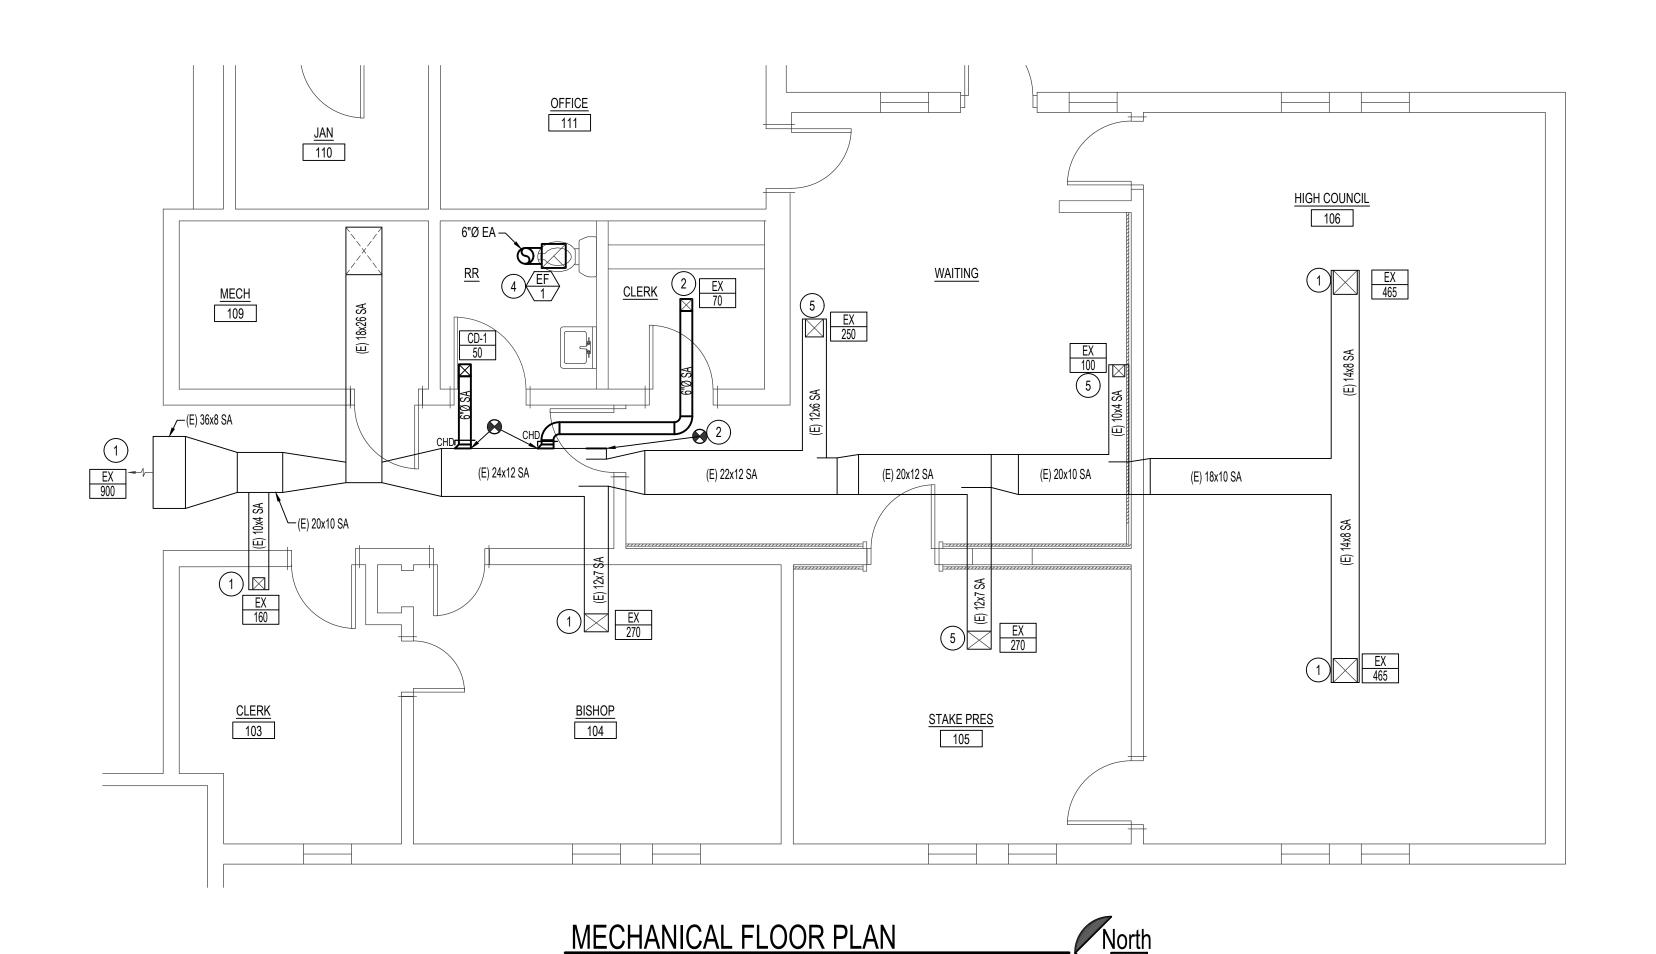



SCALE: 1/4" = 1'-0"

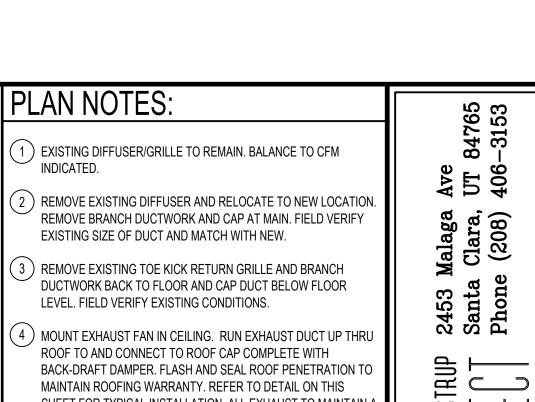

SHEET FOR TYPICAL INSTALLATION. ALL EXHAUST TO MAINTAIN A MINIMUM OF 10'-0" FROM EQUIPMENT AIR INTAKES. 5) REMOVE EXISTING DIFFUSER FOR NEW CEILING. CLEAN AND REINSTALL AFTER WORK HAS BEEN COMPLETED. BALANCE TO CFM INDICATED.

JESUS CHRIST OF LATTER-DAY SAINTS

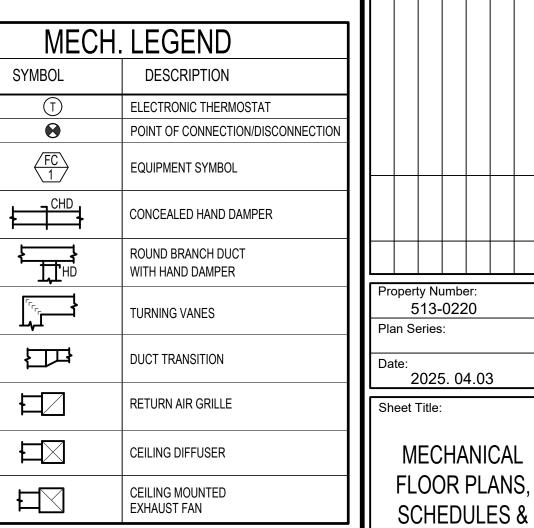

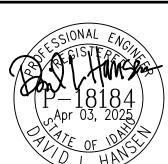





(208) 233-0501

DETAILS

FAX: (208) 233-0529 EMAIL: esa@engsystems.com ESA JOB NUMBER: 25028

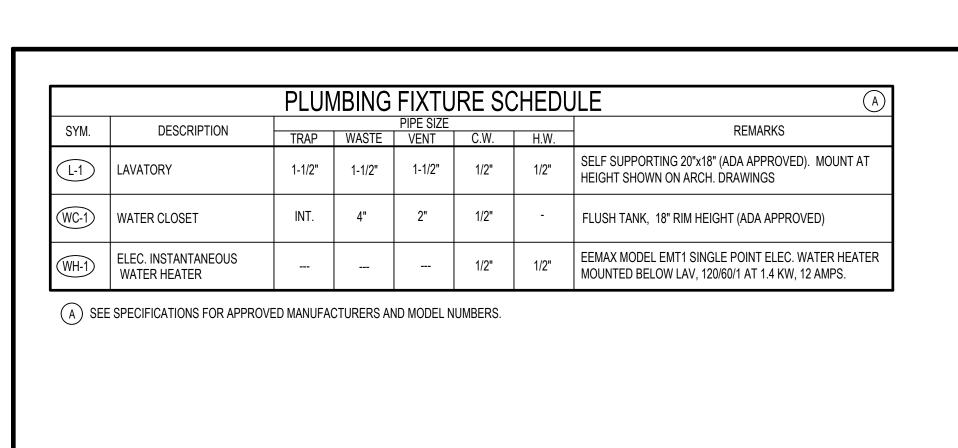

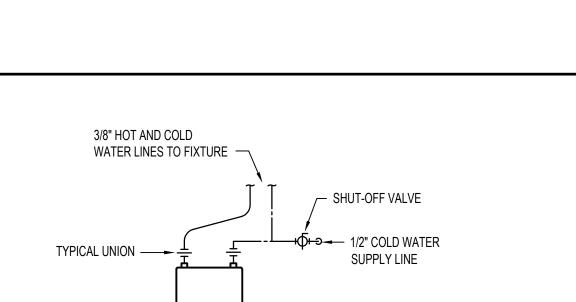

(UNDER LAVATORY)

TANKLESS WATER HEATER PIPING DETAIL

KEEP TUBING A MINIMUM OF - PEX PIPING 12" VERTICALLY OR 6" HORIZONTALLY FROM SOURCES OF HIGH HEAT SUCH AS LIGHT FIXTURES, HEAT FLUES OR HEATING

INSTANTANEOUS TYPE

WATER HEATER. MOUNT BELOW SINK


> NOTE: USE ONLY CONTINUOUS LENGTH TUBING (NO FITTINGS) WHEN INSTALLING PEX UNDER OR WITHIN A SLAB. PROTECT PEX TUBING WITH NONMETALLIC SLEEVES WHERE IT PENETRATES A SLAB OR FOUNDATION WALL.

MIN. CLEARANCES

EQUIPMENT.


- SOURCE

OUTSIDE STORAGE.

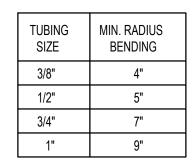

DO NOT CRUSH OR KINK TUBING




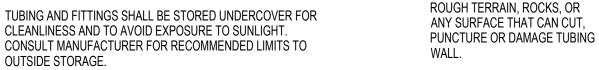


PEX PIPE HANDLING DETAILS NO SCALE


THIS TYPE (COLD EXPANSION) OF FITTING REQUIRES THAT THE PEX PIPING, WITH REINFORCING PEX RING PLACED OVER THE END OF THE PIPE, THE PIPE IS EXPANDED BEFORE THE FITTING IS INSERTED INTO THE PIPE END. THE EXPANDED PIPE END IS ALLOWED TO RETRACT ONTO THE FITTING TO FORM THE SEAL. THE MEMORY OF THE PIPE ALLOWS IT TO TIGHTEN OVER THE FITTING. AN EXPANDER TOOL IS REQUIRED TO EXPAND THE PIPE AND THE PEX RING TOGETHER.

ALL JOINTS (TEES. ELBOWS, COUPLINGS, ETC.) ARE JOINTED SIMILARLY.

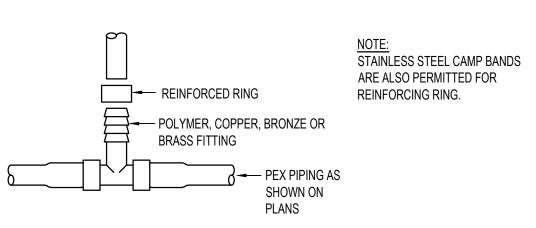


PEX PIPE FITTING DETAILS NO SCALE

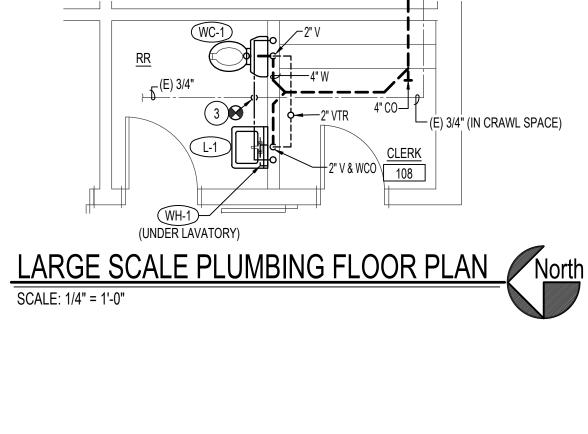

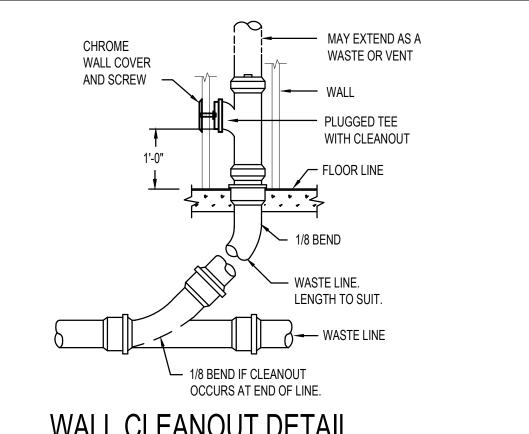

WALL CLEANOUT DETAIL NO SCALE

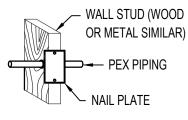

VERTICAL TUBING TO BE SUPPORTED EVERY 8'-0" WHEN PENETRATING METAL STUDS, UTILIZE A BUSHING DESIGNED FOR PLASTIC TUBING.

WALL INSTALLATION


NO SCALE


PIPE SUPPORTS: PLASTIC HANGERS AND STRAPS ARE RECOMMENDED, BUT METAL SUPPORTS WHICH ARE DESIGNED FOR USE WITH PLASTIC TUBING CAN BE

DO NOT USE SUPPORTS THAT PINCH OR CUT THE TUBING. SUPPORT SHOULD ALLOW FREE TUBING MOVEMENT. INSPECT ALL SUPPORTS PRIOR TO INSTALLATION

TO ENSURE THAT SHARP EDGES DO NOT EXIST THAT CAN DAMAGE THE TUBING.

DO NOT USE IN ANY APPLICATION WHERE TUBING WILL BE EXPOSED TO DIRECT SUNLIGHT. PEX PIPE INSTALLATION DETAILS

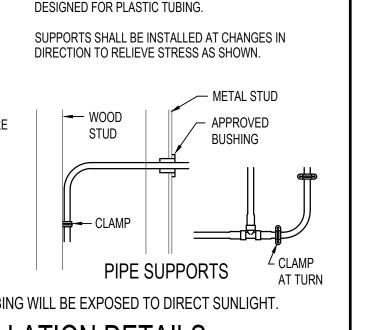

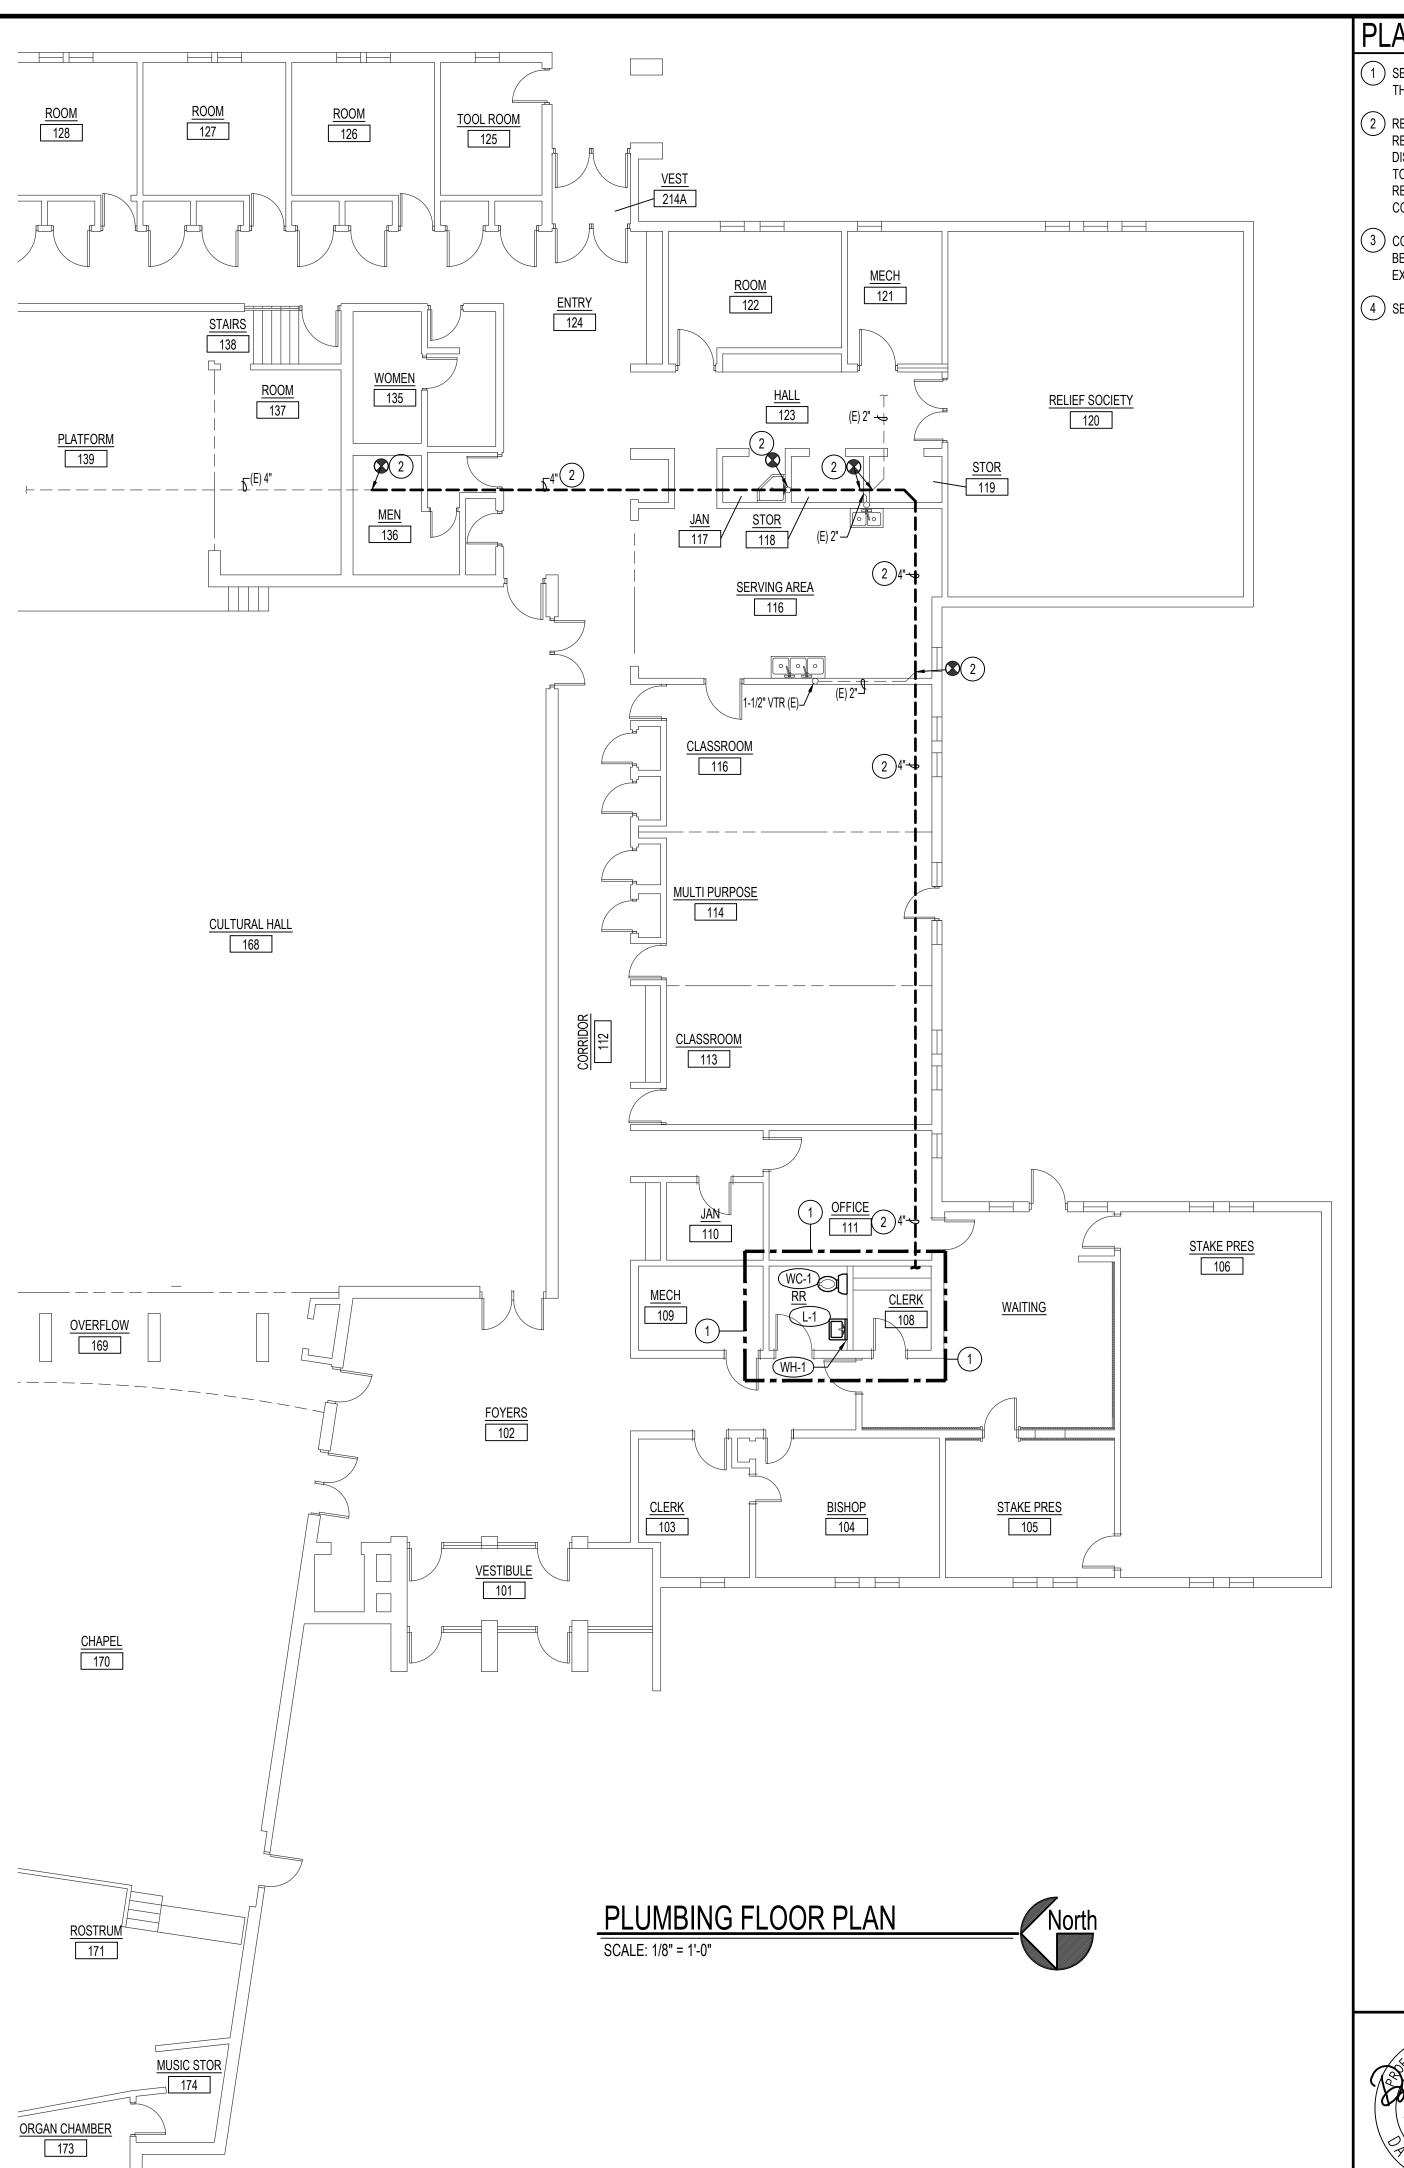




- 1) SEE LARGE SCALE PLUMBING PLAN ON THIS SHEET FOR WORK IN THIS AREA.
- P.) REMOVE EXISTING 2" WASTE LINE IN TUNNEL BELOW AND REPLACE WITH 4" WASTE AND SLOPE AT 1/4" PER FOOT. DISCONNECT EXISTING BRANCH WASTE LINES AND RECONNECT TO NEW PIPING. COORDINATE WITH GENERAL CONTRACTOR FOR REQUIRED SAW CUTTING OF FLOOR. FIELD VERIFY EXISTING CONDITIONS.
- 3) CONNECT TO EXISTING COLD WATER LINE IN CRAWL SPACE BELOW AND RISE UP IN WALL TO SERVE FIXTURES. FIELD VERIFY EXISTING CONDITIONS.
- ig(f4ig) SEE PLUMBING PLAN ON THIS SHEET FOR CONTINUATION.

HURCH OF
CHRIST
R-DAY SAINTS

JESUS COF LATTER-1

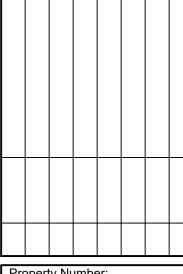

Property Number 513-0220 Plan Series:

2025. 04.03 Sheet Title:

MAIN PLUMBING FLOOR PLAN, SCHEDULES & **DETAILS**






ESA JOB NUMBER: 25028

EMAIL: esa@engsystems.com

EL	ECTRICAL SYMBOL SCHEDULE	DA	TA/COMM. SY
	LIGHTING FIXTURE	_T-X ►	TELEPHONE OUTLET (_=# 0
F#E	EMERG. FIXTURE WITH EMERG. BATTERY PACK, CONNECTED TO UNSWITCHED LEG OF LIGHTING CIRCUIT.	_D-X ►	DATA OUTLET (_=# OF CAB
	NIGHT LIGHT FIXTURE, CONNECTED FIXTURE TO UNSWITCHED LEG OF LIGHTING CIRCUIT.	_T/_D-X ►	TELE/DATA OUTLET (_=# OI
${\bigcirc}$	EXIT SIGN, WALL OR CEILING MOUNT & DIRECTIONAL ARROWS AS	_D 	TELEPHONE & DATA OUTLET
$\otimes \otimes$	INDICATED ON DRAWINGS. CONNECT TO UNSWITCHED LEG OF NEAREST LIGHTING CIRCUIT.		1. UTILIZE 4 11/16" DEEP BO TO COMMUNICATIONS E
0	CEILING MOUNTED FIXTURE WALL MOUNTED FIXTURE		BUSHING. PROVIDE QTY NEAREST TELE/DATA RO
<u>Ю</u>	RECESSED CAN FIXTURE		INFORMATION. PROVIDE ACCESSIBLE CEILING FO
8 B	EMERGENCY WALL LIGHT WITH 90MIN. BATTERY		2. CONDUIT SIZES (X): 2=1/
	TRAC LIGHT SYSTEM		3. NO LABEL INDICATES: 4 AND 1" CONDUIT TO ABO
\$	SINGLE POLE SWITCH (SEE SUBSCRIPTS) DUAL-LEVEL SWITCHES; IN-BOARD AND OUT-BOARD LAMPS SHALL BE		TRAY. TERMINATE WITH PROVIDE WITH PULL ST
\$\$	SWITCHED SEPARATELY. (SUBSCRIPT APPLIES TO BOTH SWITCHES)		LARGE CAPACITY BOX (C = 0
SWITCH SUB- SCRIPTS	3 = 3-WAY 4 = 4-WAY F = EXHAUST FAN TIMER (INTERMATIC MODEL EI400 SERIES) T = THERMAL OVERLOAD SWITCH W/PILOT LIGHT P = 1-POLE SWITCH WITH PILOT LIGHT. (SEE SPECS) M = SWITCH SUPPLIED W/ EQUIPMENT (INSTALLED BY E.C.) WP = WEATHERPROOF	•	LARGE CAPACITY 2 GAN MUDRING AND VANCO 2 12082). INSTALL A 2" CC TO A CEILING MOUNTED
\$	WALL BOX DIMMER SWITCH. (SWITCH TO BE COMPAT. W/LOAD SERVED) LED 0-10V: LEVITON RENOIR II #AWSMG-7D* W/MATCHING WALL PLATE OR EQUAL (* COLOR TO MATCH WIRING DEVICES)	(SEE SPE	ICATIONS CABLING REQUIR CIFICATIONS FOR ADDITION CCABLING - CAT6 PLENUN NE CABLING - CAT6 PLENUN
	SWITCH MOUNTED OCCUPANCY SENSOR, LINE VOLTAGE, W/ COVERPLATE, (COLOR TO MATCH WIRING DEVICES)		ON CABLING - COAXIAL, RG-
\$ ^P	P = PASSIVE INFRARED,1-POLE [WATTSTOPPER # PW-301] P2 = PASSIVE INFRARED,2-POLE [WATTSTOPPER # PW-302] D = DUAL TECHNOLOGY,1-POLE [WATTSTOPPER # DSW-100] D2 = DUAL TECHNOLOGY,2-POLE [WATTSTOPPER # DSW-200]		ERAL NOTES:
	CEILING MOUNTED OCCUPANCY SENSOR		CTRICAL CONTRACTOR SHA URE TYPE BEFORE ORDERII
S	BLANK = DUAL TECH., LINE VOLTAGE [WATTSTOPPER #DT-355] L = LARGE AREA, ULTRASONIC LOW VOLTAGE [WATTSTOPPER #WT-2205] H = HALLWAY, ULTRASONIC LOW VOLTAGE [WATTSTOPPER #WT-2255] R = RESTROOM, DUAL TECH., LINE VOLTAGE, 2-POLE [SENSOR SWITCH #CMR-PDT-9-2P], (1) RELAY FOR LTG, (1) RELAY FOR	DRA	CTRICAL CONTRACTOR SHA WINGS FOR EXACT LOCATIO CTRICAL CONNECTIONS.
	EXHAUST FAN (30 MIN. DELAY) D = INTEGRAL DAYLIGHT SENSOR TO AUTOMATICALLY CONTROL FIXTURES IN DAYLIGHT ZONES W = WALL MOUNTED ON/OFF/DIM	CLEA	CTRICAL CONTRACTOR SHA ARANCE AS PER NEC BEFOR CABINETS.
(E)	W2= WALL MOUNTED OCC SENSOR ON/OFF ONLY *PROVIDE LOW VOLTAGE SENSORS WITH POWER/RELAY PACK(S) AS REQUIRED FOR OPERATION. [WATTSTOPPER #BZ-50] PHOTOELECTRIC CELL/SWITCH	MEC	ALL ALL LIGHT FIXTURES IN HANICAL EQUIPMENT IS IN F VIDE CHAIN SUSPENSION KI
	TIME CLOCK SWITCH		ER TO ARCHITECTURAL REF URE LOCATIONS, CEILING T
•	PUSHBUTTON (AS INDICATED ON DRAWINGS)		CTRICAL CONTRACTOR SHA
Φ	DUPLEX RECEPTACLE		UIRED ON ALL ELECTRICAL
Φ	BOTTOM HALF OF RECEPTACLE SHALL BE SWITCHED		FIRM EXACT LOCATIONS OF IER PRIOR TO ROUGH - IN.
⊕	DOUBLE DUPLEX OUTLET (4-PLEX) CEILING MOUNTED DUPLEX RECEPTACLE	H. ELEC CON	CTRICAL CONTRACTOR SHA VENIENCE OUTLETS AT 18"
RECPT. SUB- SCRIPTS	AC=ABOVE COUNTER USB=RECEPTACLE W/USB CHARGER GFI=GROUND-FAULT CR=CORD REEL (SEE DETAIL) IG=ISOLATED GROUND S=SURGE SUPPRESSION TRANSPORTER PROJECTANT	I. LOCA DOO	DICAPPED REQUIREMENTS. ATE SWITCHES, OUTLETS, E RWAYS, AS CLOSE TO DOO
	TR=UL TAMPER RESISTANT WP=WEATHERPROOF COVER W/GFCI RECEPT. TV= RECPT. FOR TV, SEE ARCH. ELEVATION DWGS FOR MTG. HEIGHT		RFERE WITH ROOM CABINE PORT ALL LIGHT FIXTURES I
₽W	50A 208V 1Ø WELDER OUTLET		CTRICAL CONTRACTOR SHA
	FLOORBOX - POWER ONLY (1-DUPLEX RECEPTACLE) SUCH AS		WORK AND PAY ASSOCIAT
	HUBBELL CFB2G30/24GCCVRALU/FBNPDUP/FBNPBNK1/HBL8300GRY MULTI PURPOSE SCRUBWATER FLOOR BOX. FSR #FL200-4-CSK-S45MM-BKT-FL200-SCU-CBA.	AND	ITAIN 24" MIN. CLEARANCE I ELECTRONIC BALLASTS.
	WITH DUPLEX RECEPTACLE. E.C. SHALL COORDINATE WITH FLOOR TYPE. INSTALL (2) 2" CONDUITS TO ABOVE CEILING WITH PULL CORD FOR IT AND AV DISCONNECT SWITCH (SIZE AND TYPE AS INDICATED)		BATTERY EXIT AND EMERGI UNSWITCHED LEG OF THE I E.
	F=FUSED DISCONNECT (FUSE PER EQUIP. NAMEPLATE) B=ENCLOSED CIRCUIT BREAKER V=VFD (PROVIDED BY M.C. CONNECTED AND INSTALLED BY E.C.)	CON /CON	ESS SPECIFICALLY INDICATI TRACTOR TO COORDINATE TRA., EX. DENTAL, MEDICAL,
CS	COMPANY SWITCH WITH DISCONNECT, PIN & SLEEVE OUTLET; HUBBELL #HBL460MRW W/ HBL460P12W PLUG. SUPPLY WITH ERICSON 0S2E-01-060PCLB SPIDER BOX W/ 12 GFI RECEPTACLES. SUPPLY W/ 50FT. 4-#6 + GROUND CABLE W/ MATCHING PLUG AT SPDER BOX.	INDIC	GH-IN REQUIREMENTS FOR CATED OTHERWISE, THE EL FINAL CONNECTIONS TO AL
□	COMBINATION STARTER & FUSED DISCONNECT SWITCH; 2-SETS OF NO/NC CONTACTS, CONTROL XFMR, FUSE PER EQUIP. NAMEPLATE	ABO	CONDUIT /RACEWAY /CABLE VE CEILINGS. IF ANY SURFA
	MAIN/DISTRIBUTION PANELBOARD		ROVED BY THE ARCHITECT
_	BRANCH PANELBOARD	INVE	SHALL VISIT THE SITE PRIO STIGATE THE EXISTING COI
	TELEPHONE / DATA BOARD (GRND AS PER UTIL. CO)		PE OF WORK DESCRIBED. N E BID TO ADEQUATELY ACC
	BRANCH CIRCUIT - CONCEALED BRANCH CIRCUIT - IN FLOOR OR UNDERGROUND		CTION BOXES FOR LIGHTING RITY. THE E.C. IS RESPONSI
A-1,3		JUNG	RTY. THE E.C. IS RESPONSI CTION BOXES REQUIRED FO FARE NOT LISTED FOR "THI
1 ÆF\	DRAWING NOTE (ON THE SHEET WHERE SHOWN)	, i∏A 	
F	MECHANICAL EQUIPMENT OR DETAIL SYMBOL JUNCTION BOX		
T	THERMOSTAT W/ 3/4"CONDUIT W/PULL CORD TO MECH. UNIT *		
S	HVAC SYSTEM SENSOR - SEE MECHANICAL *		
 II	CROSS LINES SHOW # OF PHASE/NEUTRAL CONDUCTORS IF MORE THAN TWO. EQUIPMENT/ISOLATED GROUNDING CONDUCTORS ARE NOT SHOWN. PROVIDE 'GREEN' EQUIP. GROUNDING CONDUCTOR FOR ALL CIRCUITS AND ADDITIONAL ISOLATED GROUND WHERE INDICATED.		
Ē	FAN MOTOR CONNECTION POINT		
<u> </u>	MOTOR CONNECTION POINT		
A.F.F.	ABOVE FINISHED FLOOR		
B.F.G.	BELOW FINISHED GRADE ELECTRICAL CONTRACTOR		
G.C.	GENERAL CONTRACTOR		
M.C.	MECHANICAL CONTRACTOR		
NL N.T.C	NIGHT LIGHT (CONNECT TO UNSWITCHED LEG OF LTG CIRCUIT)		
N.T.S. V.I.F.	NOT TO SCALE VERIFY IN FIELD		

ROUGH-IN BOX MUD RING ORIENTATION.

SEE MECHANICAL DRAWINGS FOR CONDUIT DESTINATION AND

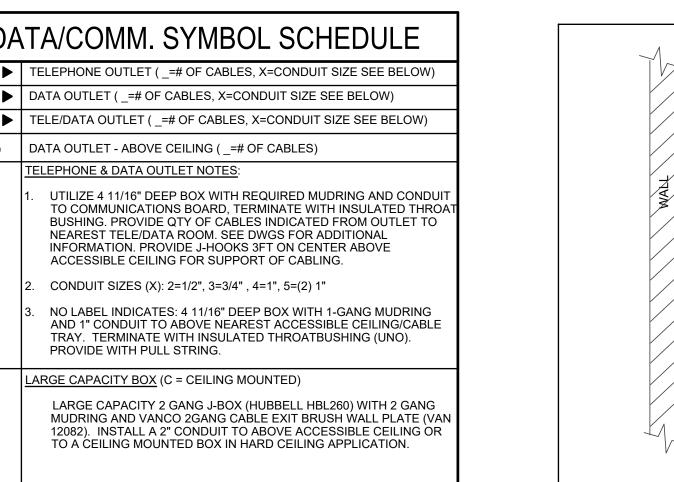


ORK CABLING - CAT6 PLENUM RATED, BLUE HONE CABLING - CAT6 PLENUM RATED, YELLOW


SION CABLING - COAXIAL, RG-6

(ALL SHEETS)

- LECTRICAL CONTRACTOR SHALL COORDINATE ALL LAMP TYPES WITH XTURE TYPE BEFORE ORDERING.
- LECTRICAL CONTRACTOR SHALL REFER TO THE MECHANICAL RAWINGS FOR EXACT LOCATION OF ALL MECHANICAL EQUIPMENT AND ECTRICAL CONNECTIONS.
- LECTRICAL CONTRACTOR SHALL PROVIDE MINIMUM WORKING LEARANCE AS PER NEC BEFORE INSTALLING ANY ELECTRICAL PANELS OR CABINETS.
- ISTALL ALL LIGHT FIXTURES IN MECHANICAL ROOM AFTER THE ECHANICAL EQUIPMENT IS IN PLACE, ADJUST AS NECESSARY. ROVIDE CHAIN SUSPENSION KITS AS REQUIRED.
- EFER TO ARCHITECTURAL REFLECTED CEILING PLAN FOR EXACT
- XTURE LOCATIONS, CEILING TYPES, ETC. LECTRICAL CONTRACTOR SHALL PROVIDE ALL CONCRETE PADS AS
- EQUIRED ON ALL ELECTRICAL EQUIPMENT. ONFIRM EXACT LOCATIONS OF ALL TELEPHONE / DATA OUTLETS WITH WNER PRIOR TO ROUGH - IN.
- LECTRICAL CONTRACTOR SHALL MOUNT SWITCHES AT 48" AND MOUNT ONVENIENCE OUTLETS AT 18" OR AS SHOWN ON PLANS TO MEET ANDICAPPED REQUIREMENTS.
- OCATE SWITCHES, OUTLETS, ETC., SHOWN AT ROOM ENTRY OORWAYS, AS CLOSE TO DOOR FRAME AS POSSIBLE, SO AS NOT TO ITERFERE WITH ROOM CABINETS, ETC.
- UPPORT ALL LIGHT FIXTURES INDEPENDENT OF CEILING.
- LECTRICAL CONTRACTOR SHALL OBTAIN ALL APPLICABLE PERMITS FOR HIS WORK AND PAY ASSOCIATED FEES.
- AINTAIN 24" MIN. CLEARANCE FROM ALL COMMUNICATIONS CABLES ND ELECTRONIC BALLASTS.
- LL BATTERY EXIT AND EMERGENCY LIGHTING TO BE CONNECTED TO HE UNSWITCHED LEG OF THE LIGHTING CIRCUIT IN THE AREA AS PER
- NLESS SPECIFICALLY INDICATED OTHERWISE, THE ELECTRICAL ONTRACTOR TO COORDINATE WITH ANY SPECIAL SYSTEMS SUPPLIER CONTR., EX. DENTAL, MEDICAL, KITCHEN, EQUIPMENT ETC. THE EXACT OUGH-IN REQUIREMENTS FOR THERE EQUIPMENT. ALSO UNLESS IDICATED OTHERWISE, THE ELECTRICAL CONTR. TO BE RESPONSIBLE OR FINAL CONNECTIONS TO ALL SPECIAL EQUIPMENT.
- LL CONDUIT /RACEWAY /CABLES, TO BE CONCEALED IN WALLS OR BOVE CEILINGS. IF ANY SURFACE WORK IS NECESSARY, IT SHALL BE PPROVED BY THE ARCHITECT /ENGINEER PRIOR TO DOING ANY WORK.
- .C. SHALL VISIT THE SITE PRIOR TO BID AND THOROUGHLY IVESTIGATE THE EXISTING CONDITIONS, AS THEY RELATE TO THE COPE OF WORK DESCRIBED. MAKE NECESSARY PROVISIONS IN THE ASE BID TO ADEQUATELY ACCOMMODATE THESE CONDITIONS.
- INCTION BOXES FOR LIGHTING CIRCUITING ARE NOT SHOWN FOR LARITY. THE E.C. IS RESPONSIBLE FOR PROVIDING AND INSTALLING ALL INCTION BOXES REQUIRED FOR CIRCUITING OF ALL LIGHT FIXTURES HAT ARE NOT LISTED FOR "THROUGH-BRANCH CIRCUIT WIRING".

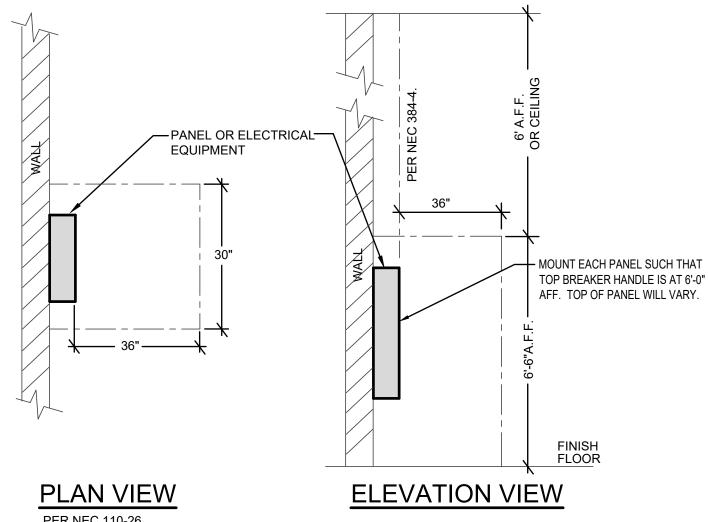

ELECTRICAL EQUIP. CLEARANCE DETAIL

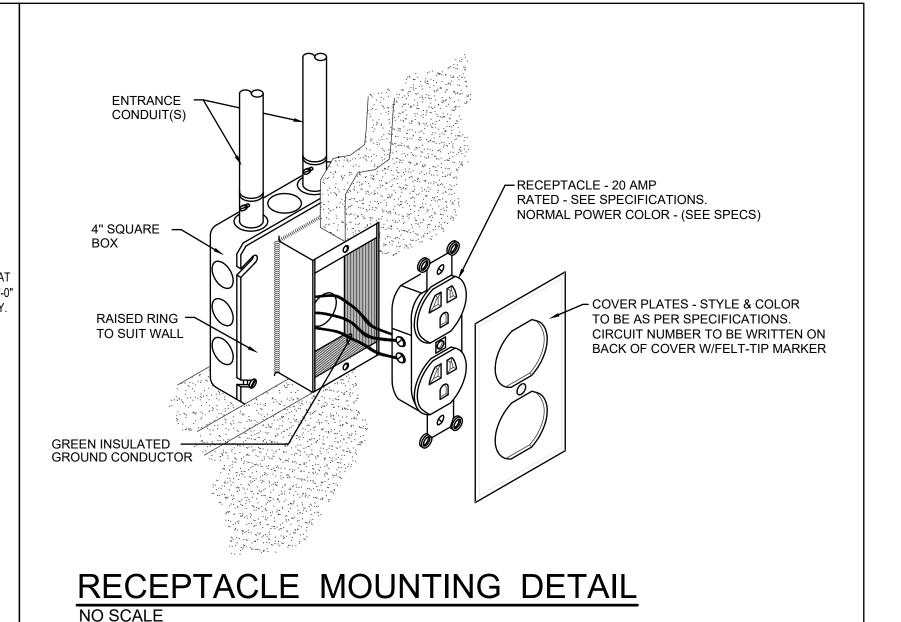

THERMOSTAT OR MECHANICAL SWITCH -VERIFY WITH MECH. LIGHT SWITCH MUD RING ORIENTATION. CONVENIENCE OUTLET TELEPHONE / DATA OUTLET -@ MILLWORK T.V. OUTLET A. ALL MOUNTING HEIGHTS TYPICAL UNLESS NOTED OTHERWISE. B. COORDINATE OUTLET HEIGHTS WITH ARCHITECTS MILLWORK DWGS. TO 5' - 0" INSURE THAT OUTLETS WILL NOT FALL BEHIND CABINETS, BACKSPLASHES, OR INTERFERE WITH WAINSCOTING, ETC. (OR AS NOTED) D. ALL SWITCHES AND THERMOSTATS TO BE MOUNTED AS CLOSE TO DOOR JAMBS AS POSSIBLE. COORDINATE ALL DEVICES WITH ARCHITECTURAL PLANS AND DETAILS. * COORDINATE LIGHT SWITCH & OUTLET (OR AS NOTED) HEIGHTS WITH ARCHITECTURAL WAINS-COTING AND OR TILE WORK SO AS NOT TO FALL MIDWAY IN THESE FINISHES. FINISHED FLOOR

TYPICAL DEVICE MOUNTING HEIGHTS DIAGRAM

NO SCALE

ORIGINAL SIGNED BY: TODD E. PAYNE DATED ORIGINAL SIGNED: 4-4-2025 ON FILE AT: PAYNE ENGINEERING INC

P.E. JOB #2541 **IPAYNE** Engineering Inc. 1823 E. Center Pocatello, Idaho 83201 tel (208) 232-4439

www.payneengineeringinc.com

 \forall

JAMES K.

E-1.0

Property Number: 513-0220

2025.04.04


Plan Series:

Sheet Title:

Electrical Details


EXISTING ELECTRICAL KEY NOTES

- DISCONNECT AND REMOVE EXISTING DEVICE IN CONFLICT WITH REMODEL. REMOVE ALL ASSOCIATED CONDUIT AND WIRE BACK TO NEXT ACTIVE BOX OR SOURCE. RESTORE ELECTRICAL CONTINUITY TO EXISTING DEVICES TO REMAIN.
- 2 REPLACE EXISTING DEVICE WITH NEW DEVICE AND COVER PLATE.
- 3 DISCONNECT AND REMOVE EXISTING FIXTURE. MAINTAIN POWER AND CONTROLS FOR NEW LIGHTING
- DISCONNECT AND REMOVE EXISTING LIGHT FIXTURE AND ALL ASSOCIATED CONDUIT AND CONTROLS. MAINTAIN CIRCUIT FOR NEW LIGHTING AND CONTROLS.
- (5) CAREFULLY REMOVE EXISTING SPEAKER AND REINSTALL AFTER NEW TILE IS INSTALLED.
- 6 EXISTING EXIT SIGN TO REMAIN. REMOVE EXISTING SURFACE MOUNTED CONDUIT AND CONNECT EXIT SIGN TO UNSWITCHED LEG OF LIGHTING CIRCUIT.
- 7 EXISTING DEVICE TO REMAIN. PROTECT DURING CONSTRUCTION.

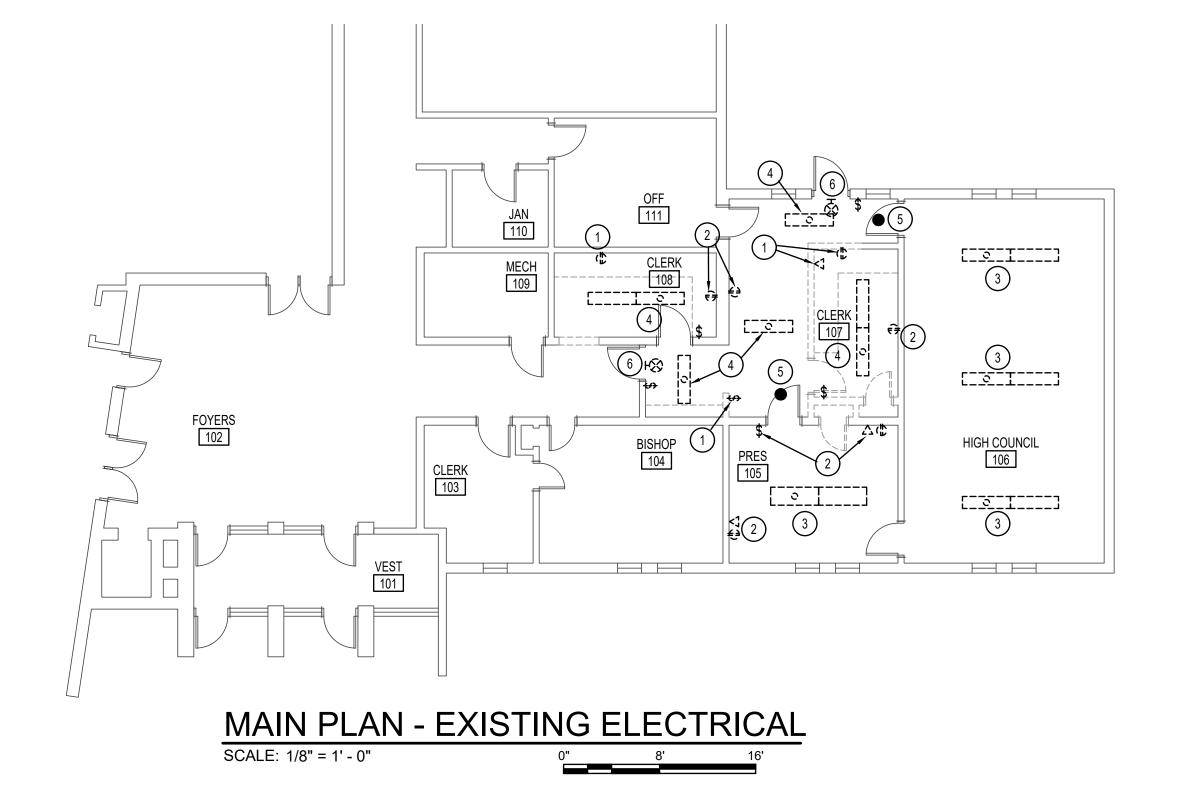

ELECTRICAL KEY NOTES

- CONNECT NEW FIXTURE TO EXISTING LIGHTING CIRCUIT AND CONTROLS.
- (2) CONNECT NEW FIXTURE TO EXISTING LIGHTING CIRCUIT. PROVIDE NEW CONTROLS AS SHOWN.
- (3) CONNECT TO EXISTING RECEPTACLE CIRCUIT.
- PROVIDE AND INSTALL A DATA CONNECTION AT THIS LOCATION. UTILIZE EXISTING CABLING IF POSSIBLE. EC SHALL COORDINATE LOCATION AND REQUIREMENTS WITH LOCAL FM.
- 5 EC SHALL PROVIDE AND INSTALL A NEW 20A 120V CIRCUIT TO NEW WATER HEATER. CONNECT TO NEAREST SPARE 20A BREAKER. EC SHALL FIELD VERIFY PRIOR TO BIDDING.

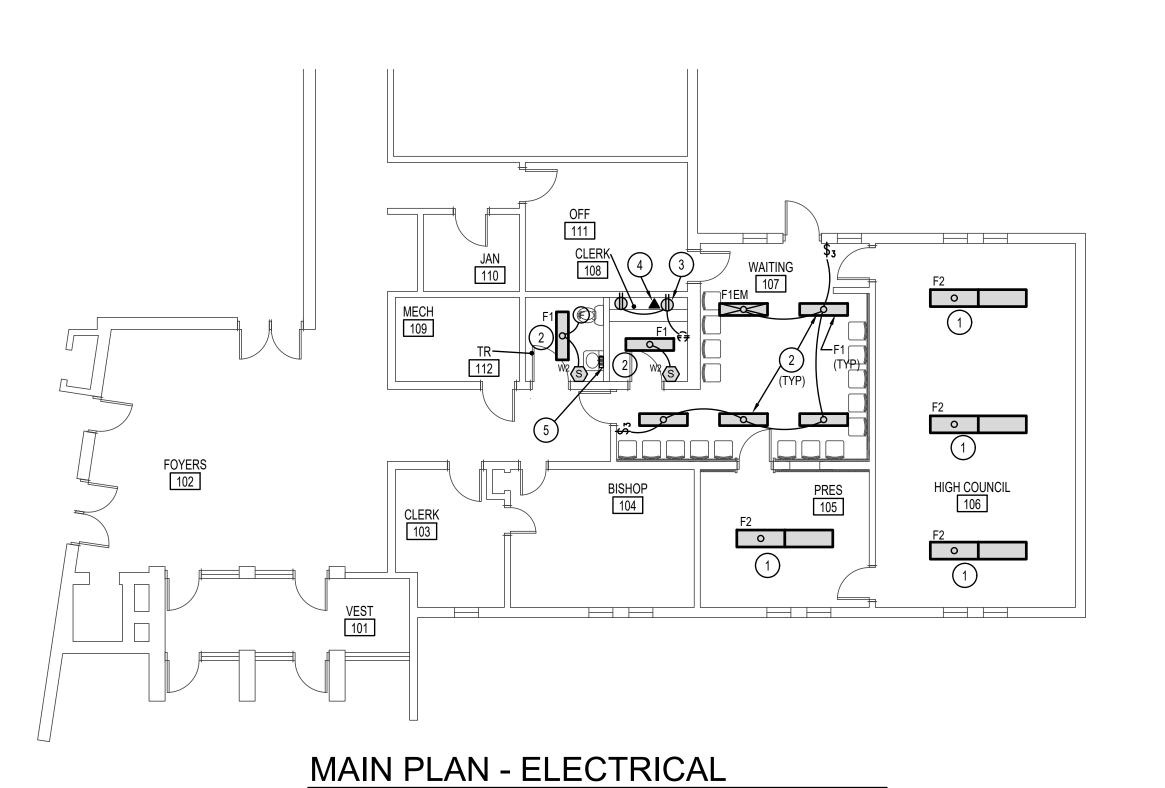

		LIG	НТ	FIXTURE	SCHEDULE	1., 2.	
TYPE	DESCRIPTION	MOUNT	VOLT	LAMPS	MFGR.	CATALOG #	NOTES
F1	4 FT LED WRAP NARROW BODY	CEILING	120/277	INCLUDED	LITHONIA	LBL4 4800LM 80CRI 35K NODIM MVOLT NO SUBSTITUTION, MATCHING EXISTING	
F2	4 FT LED WRAP WIDE BODY	CEILING	120/277	INCLUDED	LITHONIA	LBL4W 6500LM 80CRI 35K NODIM MVOLT NO SUBSTITUTION, MATCHING EXISTING	

FIXTURE NOTES:

THE SUFFIX "EM" DENOTES A FIXTURE SUPPLIED WITH AN EMERGENCY BATTERY BALLAST.
 WIRE SUCH THAT UNDER NORMAL POWER CONDITIONS THE FIXTURE WILL

SCALE: 1/8" = 1' - 0"

- OPERATE WITH THE INDICATED SWITCHING, UPON LOSS OF UTILITY WILL TRANSFER TO BATTERY.
- 2. ALL BATTERY FIXTURES ARE TO BE CONNECTED TO THE UNSWITCHED LEG OF LIGHTING CIRCUIT FEEDING THE AREA.





tel (208) 232-4439

www.payneengineeringinc.com

JESUS (

Property Number: 513-0220
Plan Series:

Date: 2025.04.04

Sheet Title:

Electrical
Floor Plans

Sheet:

E-2.0