

# THE CHURCH OF JESUS CHRIST OF LATTER-DAY SAINTS


# BLACKFOOT IDAHO WEST STAKE OFFICE RENOVATION

	DRAWING INDEX		DRAWING II	NDEX	DRAWING INDEX		
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	GENERAL						
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	331211311221						
	ARCHITECTURAL						
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A2	DETAILS						
A3	DETAILS						
	MECHANICAL						
M1.1	MECHANICAL FLOOR PLANS, SCHED & DETAILS						
P1.1	PLUMBING FLOOR PLANS, SCHED & DETAILS						
	ELECTRICAL						
E-1.0	ELECTRICAL DETAILS						
E-2.0	ELECTRICAL FLOOR PLANS						
				J			

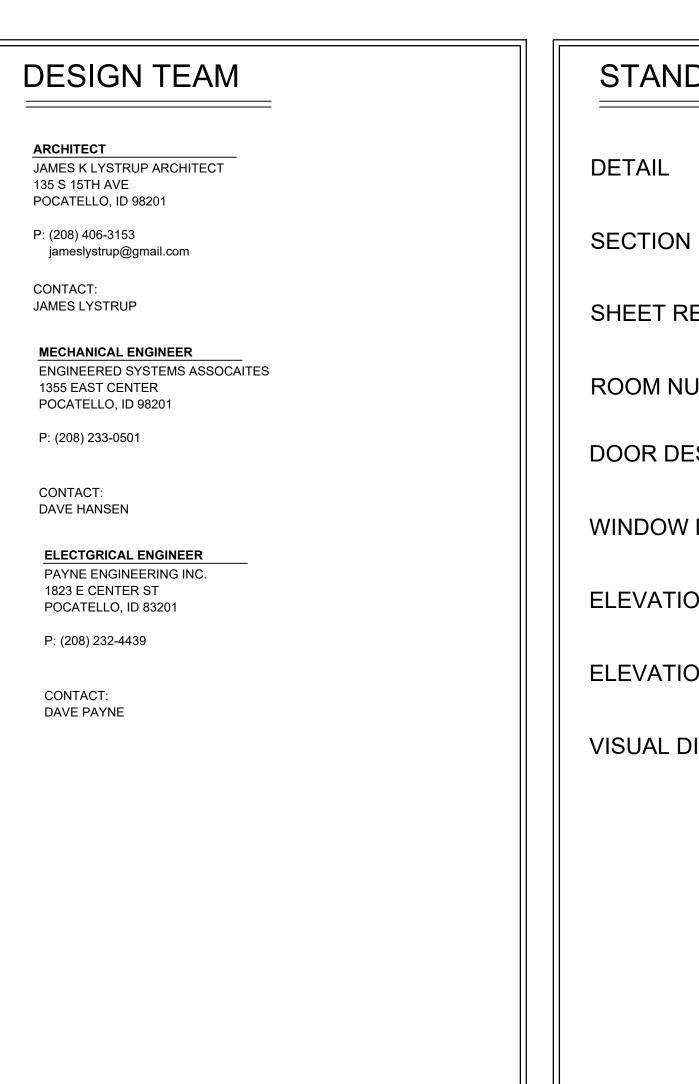

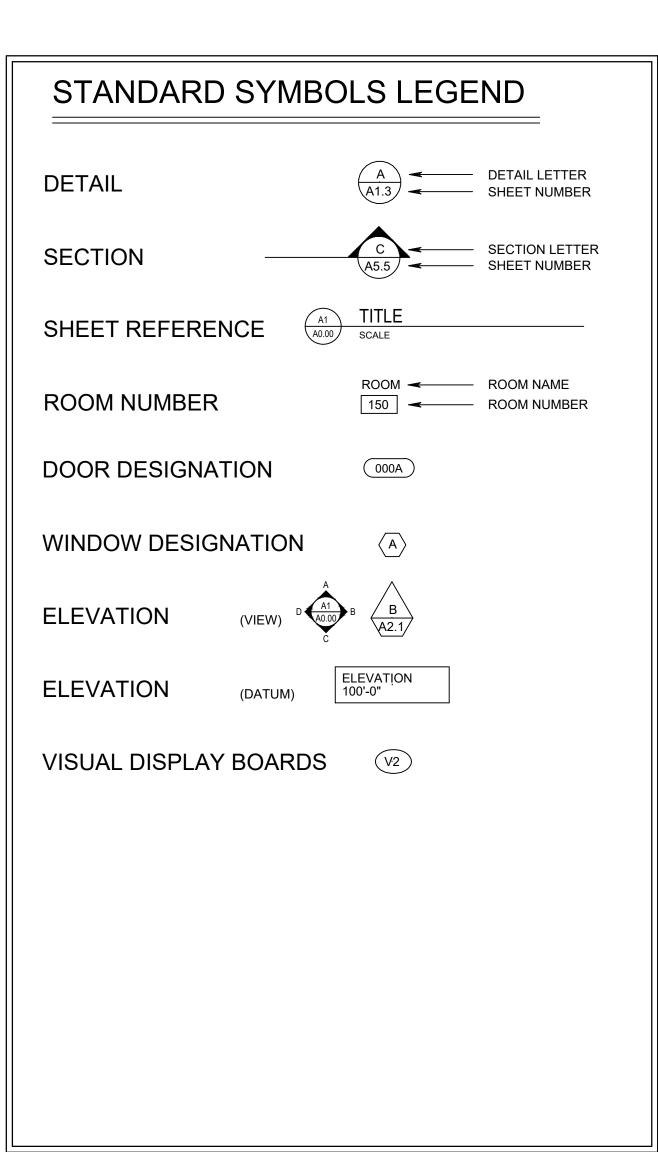




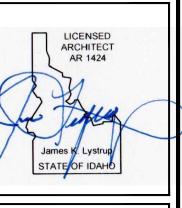

VEST STAKE OFFICE
RENOVATION

THE CHURCH OF

JESUS CHRIST
OF LATTER-DAY SAINTS

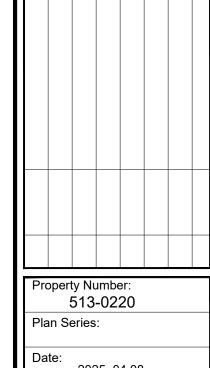


Date: 2025. 04.08


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COVER SHEET
INDEX

Sheet:

G1



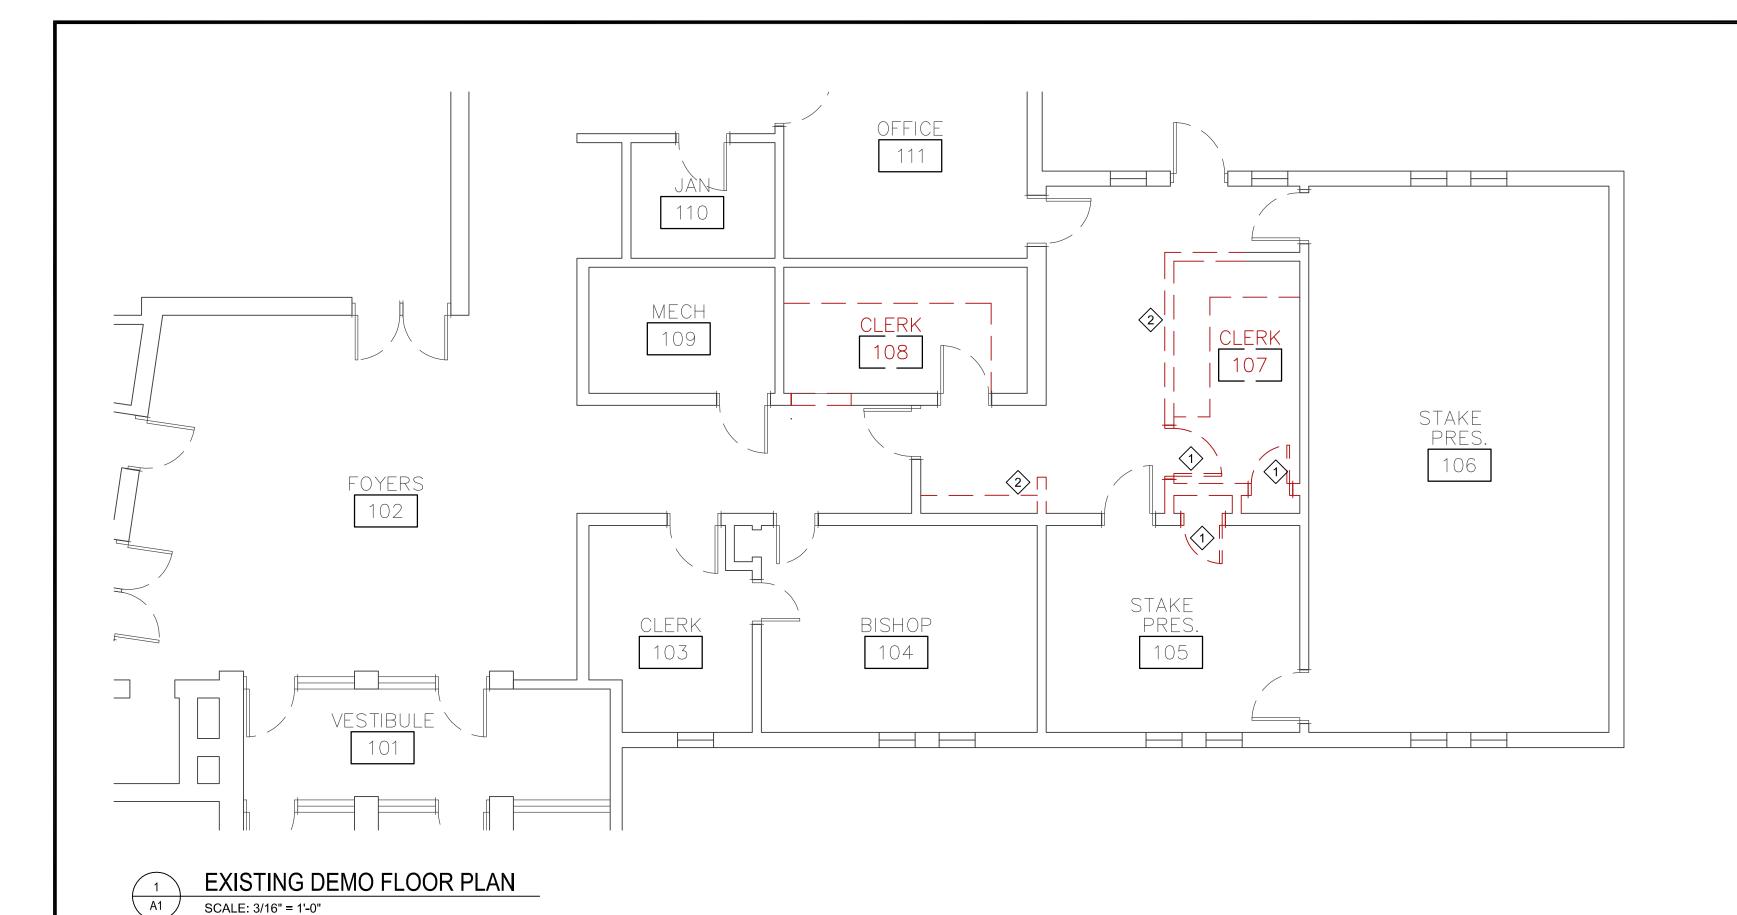

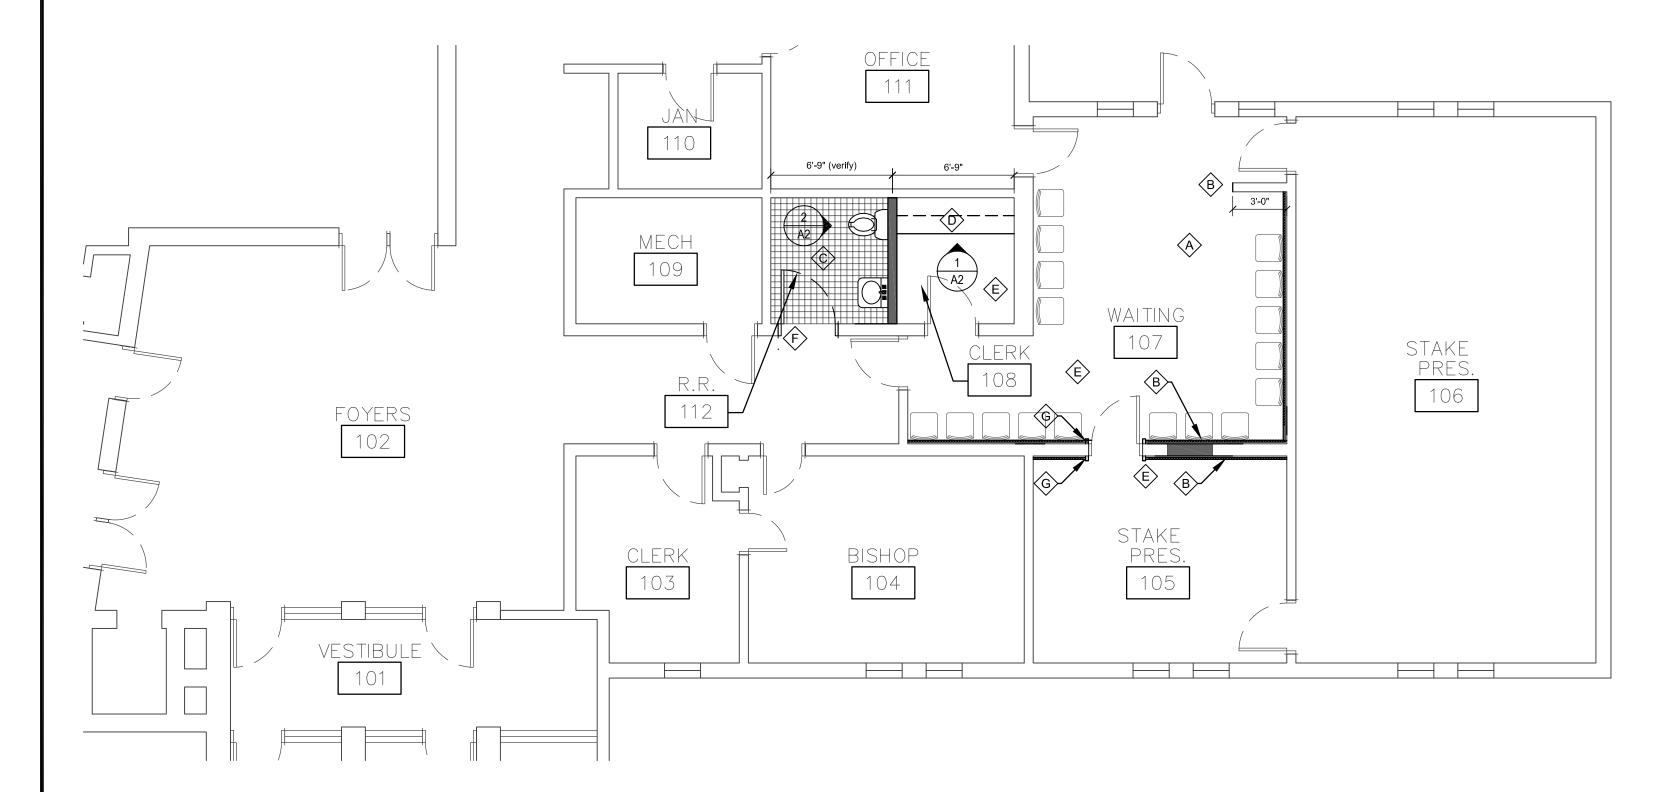NEW CONSTRUCTION PLAN

SCALE: 3/16" = 1'-0"

#### DEMO KEY NOTES


- 1 REMOVE EXISTING DOOR AND FRAME
- 2 REMOVE EXISTING WALL
- 3 REMOVE MILLWORK

#### NEW CONSTRUCTION KEY NOTES

- PATCH EXISTING CEILING GRID AND TILE AS NEEDED AT LOCATION OF WALL REMOVAL.
- B INFILL WALL CMU WALL OPENING WITH 2X WOOD FRAMING. INSTALL 1/2 GYP BOARD WALLS OVER INTIRE SURFACE OF CMU WALL, FLOAT WALLS WITH MUD, APPLY SISAL WAINSCOT, WOOD CHAIR RAIL AND VINYL WALL COVERING.
- © INSTALL NEW THRESHOLDS, FLOOR TILE, WALL TILE, PARTITIONS, FIXTURES, VANITIES, MIRRORS, GRAB BARS AND TISSUE DISPENSER.S
- (D) INSTALL NEW CASEWORK
- E INSTALL NEW CARPET BASE, CHAIR RAIL, AND WALL COVERING AND PAINT TO MATCH EXISTING
- F) INSTALL NEW 3'-0"x7'-0" SOLID CORE DOOR WITH PAINTED METAL FRAME TO MATCH EXISTING
- (G) INSTALL NEW 1X2 WOOD TRIM AT EXISTING DOOR FRAME

#### **NEW CONSTRUCTION NOTES**

- A. CONTRACTOR TO VERIFY ALL DIMENSIONS ON SITE. DIMENSIONS PROVIDED ARE ASSUMED FROM FACE OF GYP BOARD
- PROVIDE SOLID BLOCKING IN THE WALLS AT DOOR STOPS, CHALKBOARDS, TACK BOARDS, TOILET COMPARTMENTS, VANITY & BENCH BRACKETS AND OTHER EQUIPMENT AND ACCESSORY LOCATIONS.
- C. WHERE NEW FINISHES ARE INSTALLED OVER EXISTING SURFACES, PROVIDE ADJUSTMENTS IN THICKNESS AS REQUIRED - BY EXTENDING ELECTRICAL "J" BOX FOR SWITCHES, OUTLETS, CONTROLS, ETC. EXTEND MECHANICAL DUCTWORK, PIPING, ETC.
- D. PROVIDE STRAIGHT, EVEN FRAMING. CROWN FRAMING SAME DIRECTION - LAY 10' STRAIGHT EDGE ON FRAMING & POWER PLANE AS REQUIRED TO REMOVE DISTORTION PRIOR TO INSTALLING FINISH
- E. REVIEW FRAMING CONDITIONS WITH ARCHITECT PRIOR TO INSTALLING FINISH SURFACES.
- ADJUST ALL DOOR HEIGHTS AS REQUIRED TO PROVIDE 1/2" CLEARANCE FROM FINISHED FLOOR.

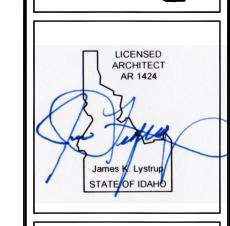

JAMES K.
RCHI


84765 -3153

Malaga 1 Clara, e (208)

BLACKFOOT IDAHO WEST STAKE OFFICE RENOVATION 101 NORTH 900 WESTACKFOOT IDAHO 833

THE CHURCH OF

JESUS CHRIST
OF LATTER-DAY SAINTS

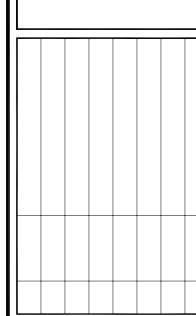

Property Number: 513-0220 Plan Series:

2025. 04.08

Sheet Title: EXISTING / DEMO PLAN

CONSTRUCTION

**A**1

FINISH SCHED.

Sheet:

FINISH SCHEDULE WALLS SPECIAL WEST **ROOM NAME** BASE TRIM OR EAST **EQUIPMENT** BASEMENT 005 STAKE PRE. OFFICE S2 - NORTH WALL EX EX 007 WAITING W7 W7 EX EX C3 S2 - SOUTH AND EAST WALL 008 CLERK OFFICE F1 W4 W4 W4 W4 C3 S4 - NORTH WALL 012 REST ROOM F3 B2 W3 W3 W3 W3 C4

#### DESCRIPTION

F FLOOR WALLS SISAL WALL COVERING F1 CARPET VINYL WALL COVERING

F2 WOOD FLOOR SYSTEM CERAMIC TILE WAINSCOT W/ PAINTED GYPSUM BOARD ABOVE, SEE ELEV. F3 TILE SISAL WAINSCOT WITH PAINTED GYPSUM BOARD ABOVE F4 CONCRETE - PAINTED

GYPSUM BOARD - PAINTED F5 3/4" SHEATHING - PAINTED GYPSUM BOARD - TAPED - NOT PAINTED F6 CARPET TILE SISAL WAINSCOT WITH VINYL WALL COVERING ABOVE, F7 VCT TILE

BASE

B1 CARPET COVED TILE 4" RUBBER

CEILING SUSPENSION SYSTEM WITH GYPSUM BOARD - PAINTED ACOUSTIC TILE ON GYPSUM BOARD NONE METAL ANGLE

GYPSUM BOARD - SKIP TROWEL FINISH - PAINTED GYPSUM BOARD - PAINTED B6 CERAMIC TILE GYPSUM BOARD - TAPED - NOT PAINTED

GYPSUM BOARD

CEILING

ACOUSTICAL TILE

CEILING SUSPENSION SYSTEM WITH GYPSUM BOARD AND


SPECIAL TRIM OR EQUIPMENT

S1 WOOD TRIM S2 CHAIR RAIL

S3 CABINETS

OTHER

EX EXISTING TO REMAIN

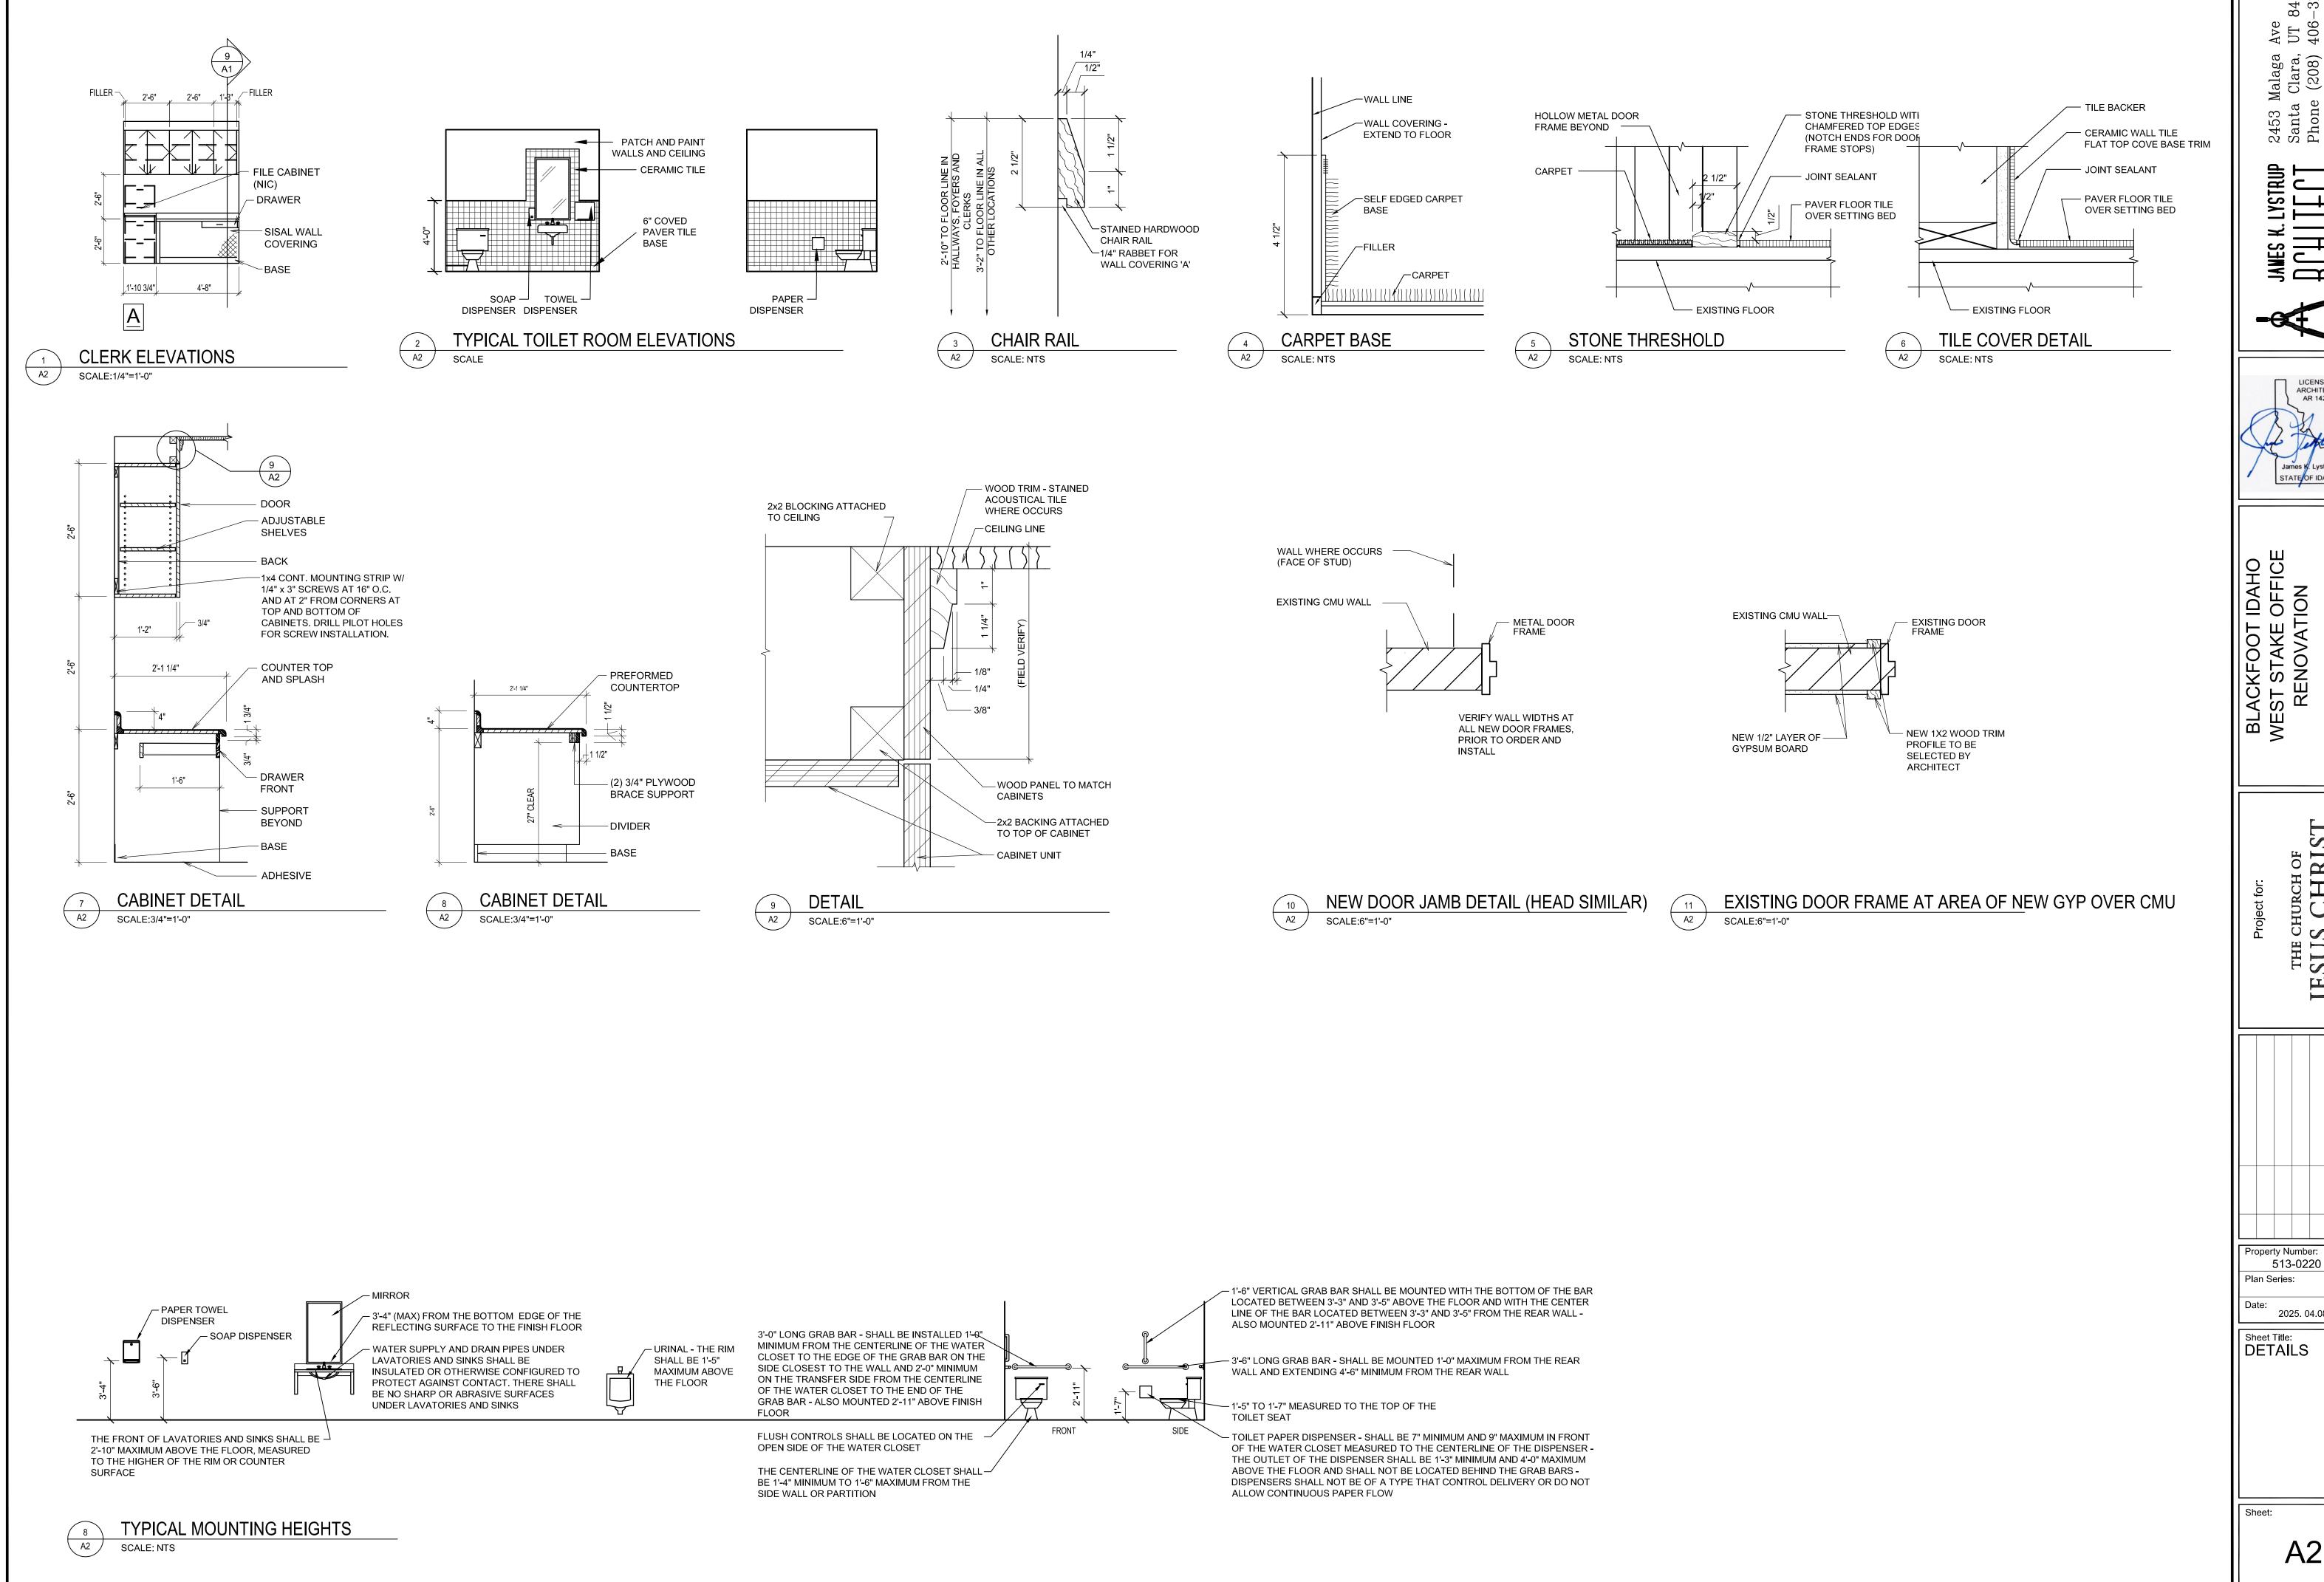

84765 -3153

Malaga Clara, (208)


LICENSED ARCHITECT AR 1424


513-0220

2025. 04.08


GRILLE AND REGISTER SCHEDULE										
SYM.	TYPE	SIZE	CFM RANGE	THROW PATTERN	CONSTR.	FINISH	BALANCING DAMPER	MAX NC RATING	REMARKS	
CD-1 CFM	CEILING	6x6	50-100	2 WAY CORNER	STEEL	WHITE	NO	20	PRICE MODEL SMD IN BEVELED FRAME	


EXHAUST FAN SCHEDULE									
SYM.	TYPE	C.F.M.	S.P.E.	WATTS	WEIGHT	CHAR.	R.P.M.	CONTROL	REMARKS
EF 1	CEILING MOUNTED	70	0.25	26.9	N/A	120/60/1	840	WITH LIGHTS SEE ELEC.	TWIN CITY T080E WITH EXHAUST DUCT TO ROOF CAP.

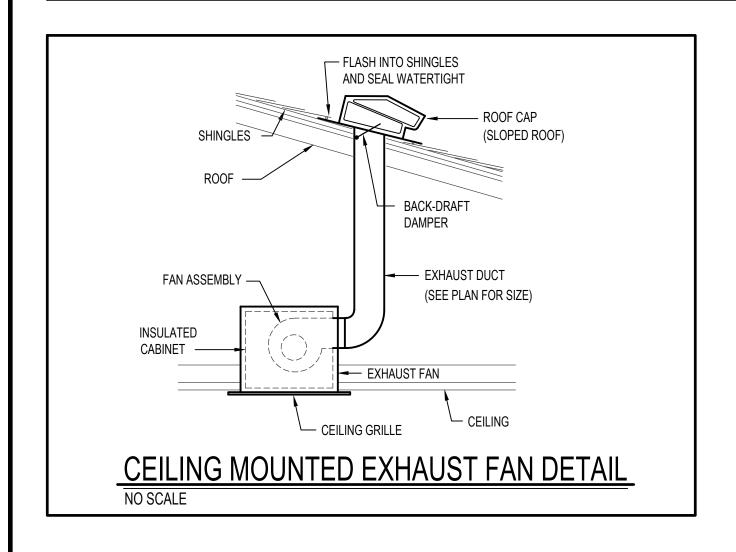

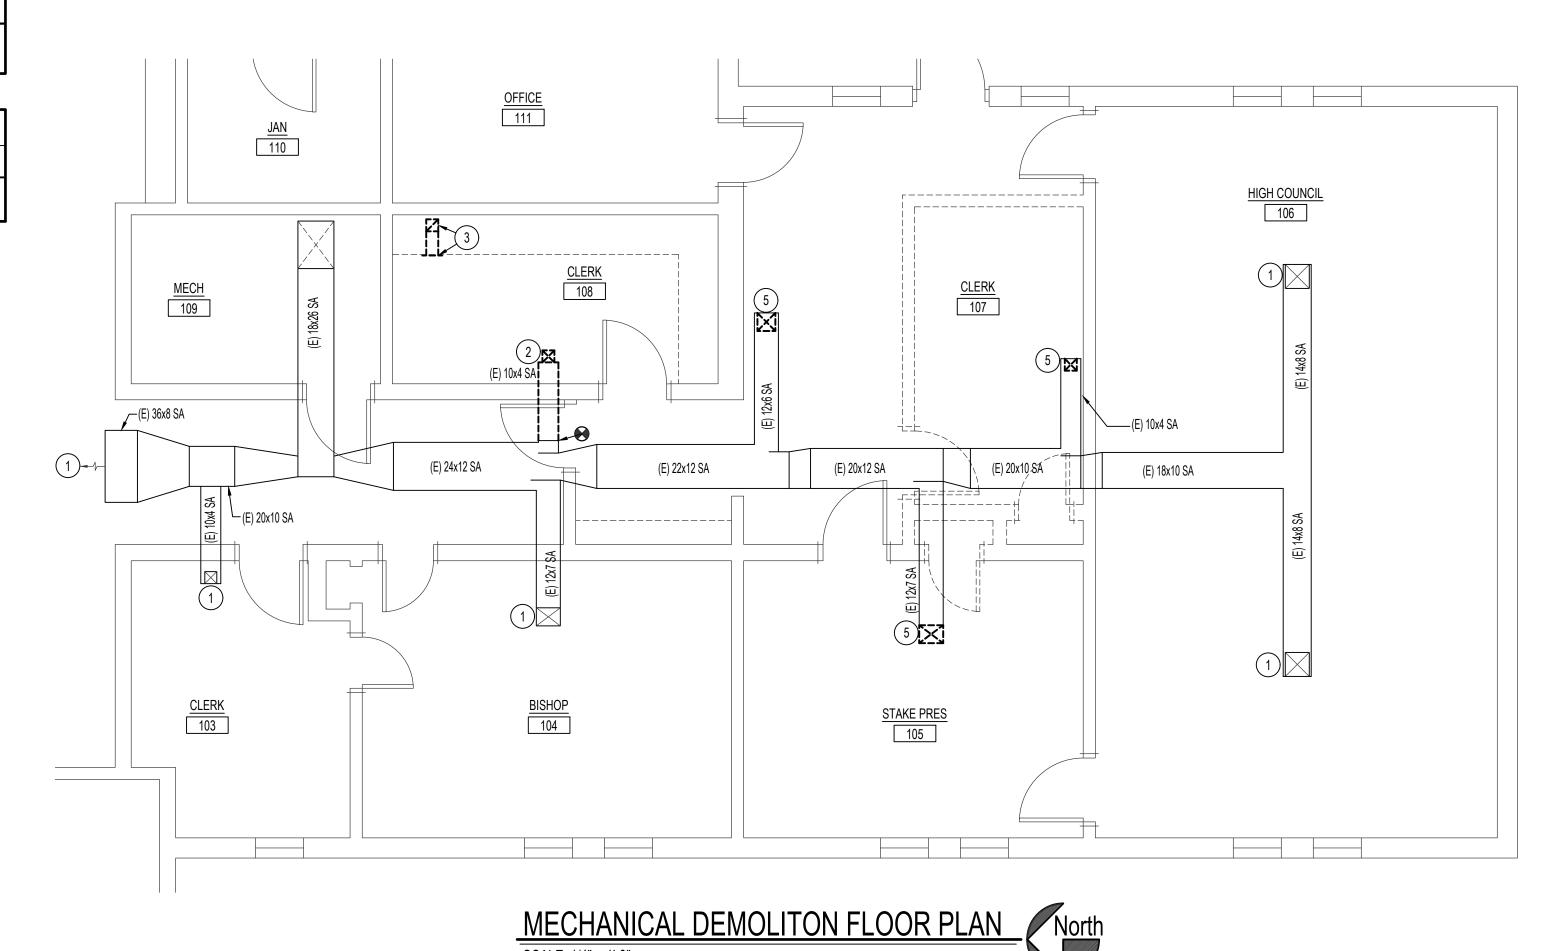

SCALE: 1/4" = 1'-0"

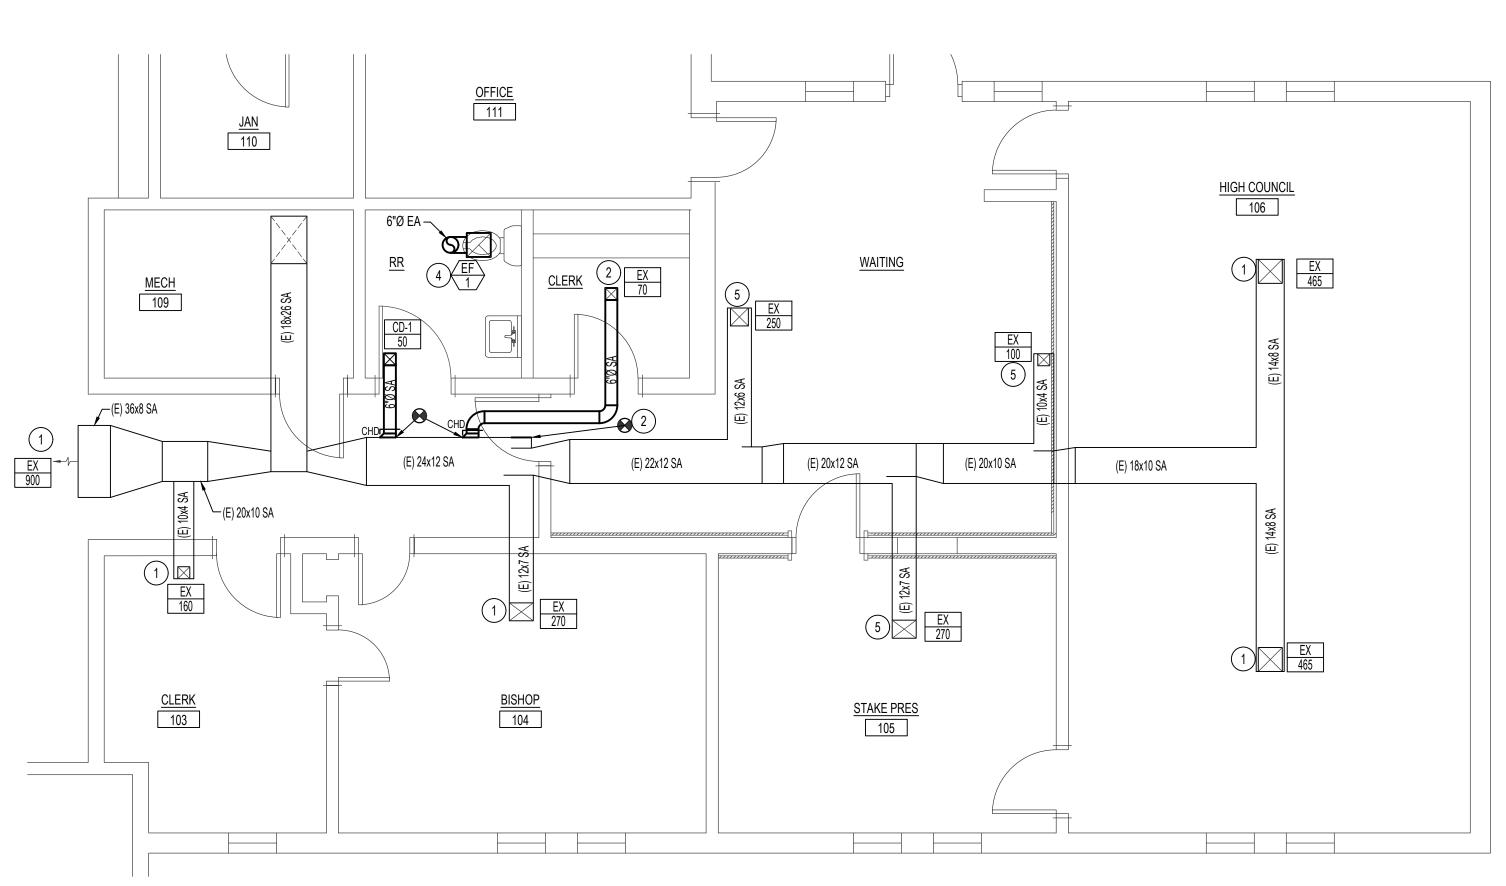

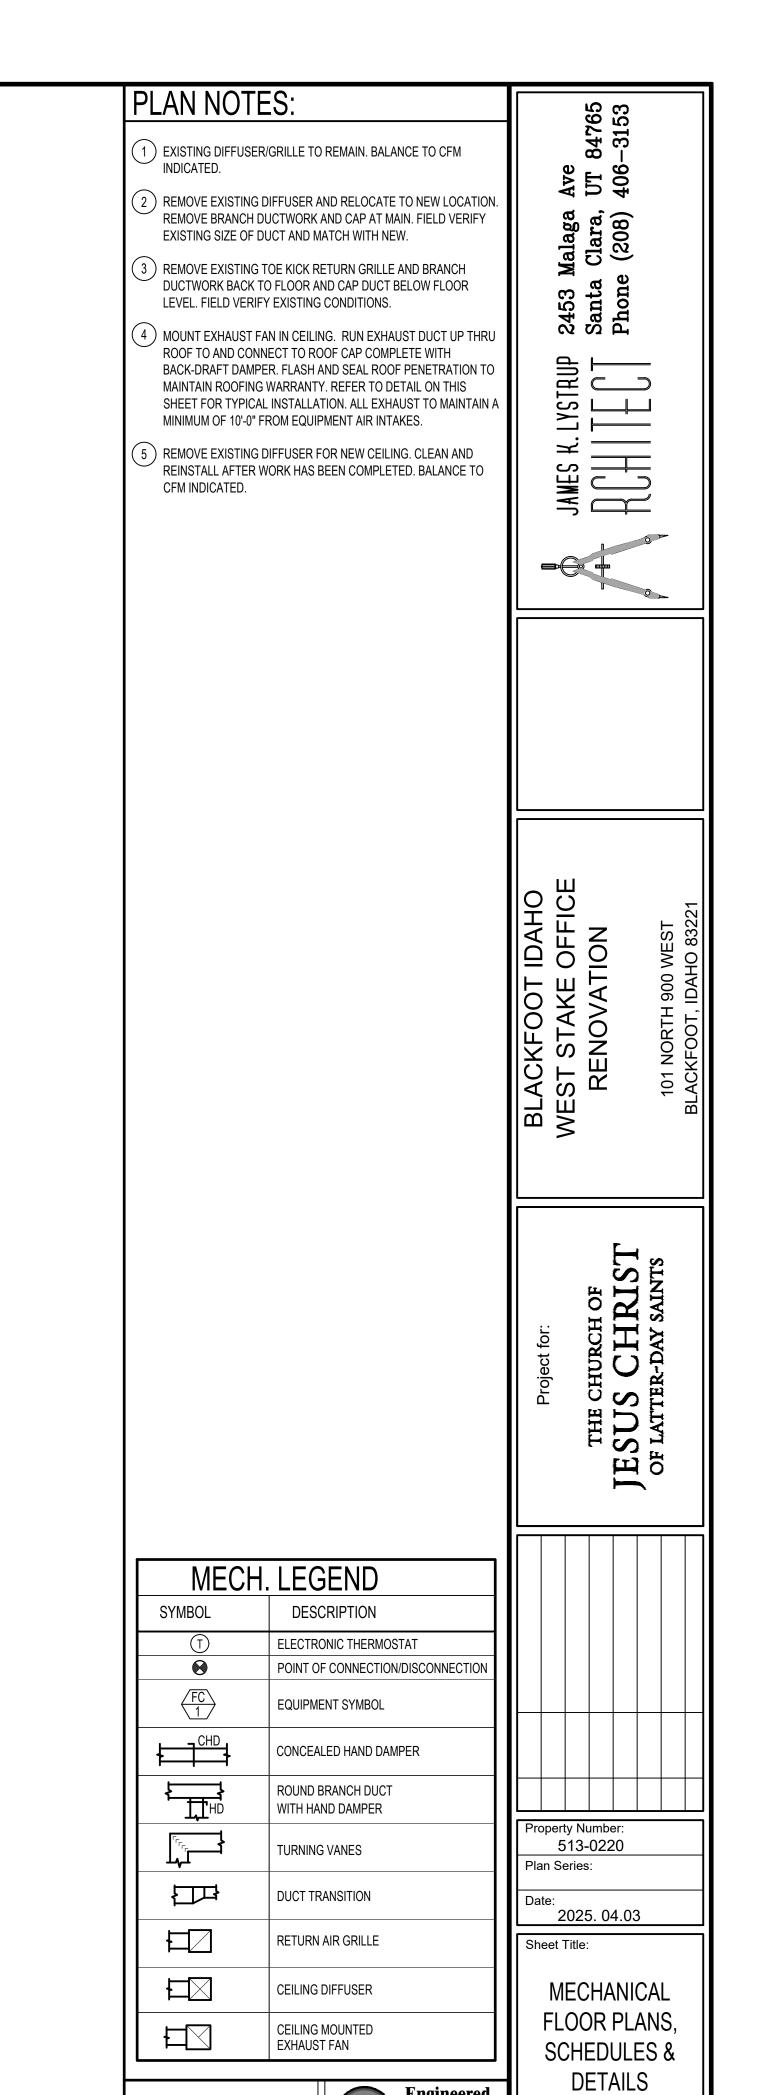










1355 EAST CENTER
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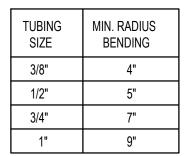
### TANKLESS WATER HEATER PIPING DETAIL

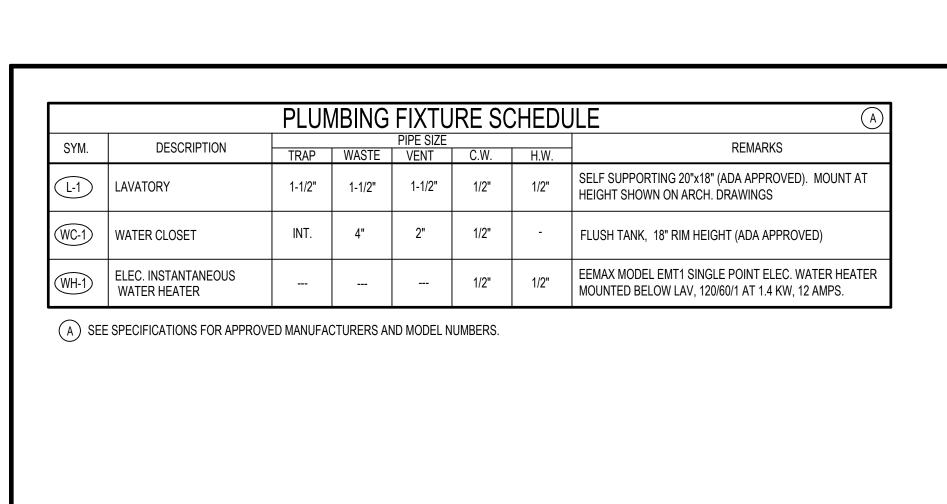

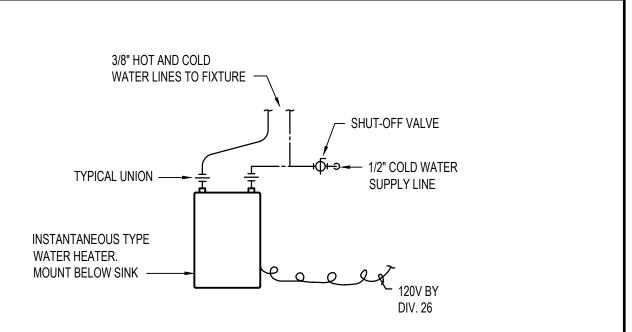KEEP TUBING A MINIMUM OF

NOTE: USE ONLY CONTINUOUS LENGTH TUBING (NO FITTINGS) WHEN INSTALLING PEX UNDER OR WITHIN A SLAB. PROTECT PEX TUBING WITH NONMETALLIC SLEEVES WHERE IT PENETRATES A SLAB OR FOUNDATION WALL.
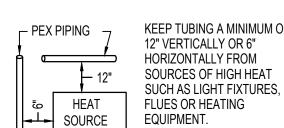
#### MIN. CLEARANCES




TUBING AND FITTINGS SHALL BE STORED UNDERCOVER FOR

CONSULT MANUFACTURER FOR RECOMMENDED LIMITS TO

CLEANLINESS AND TO AVOID EXPOSURE TO SUNLIGHT.

OUTSIDE STORAGE.


DO NOT CRUSH OR KINK TUBING

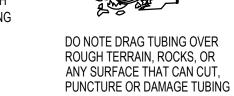

#### PEX PIPE HANDLING DETAILS NO SCALE


THIS TYPE (COLD EXPANSION) OF FITTING REQUIRES THAT THE PEX PIPING, WITH REINFORCING PEX RING PLACED OVER THE END OF THE PIPE, THE PIPE IS EXPANDED BEFORE THE FITTING IS INSERTED INTO THE PIPE END. THE EXPANDED PIPE END IS ALLOWED TO RETRACT ONTO THE FITTING TO FORM THE SEAL. THE MEMORY OF THE PIPE ALLOWS IT TO TIGHTEN OVER THE FITTING. AN EXPANDER TOOL IS REQUIRED TO EXPAND THE PIPE AND THE PEX RING TOGETHER.


ALL JOINTS (TEES. ELBOWS, COUPLINGS, ETC.) ARE JOINTED SIMILARLY.

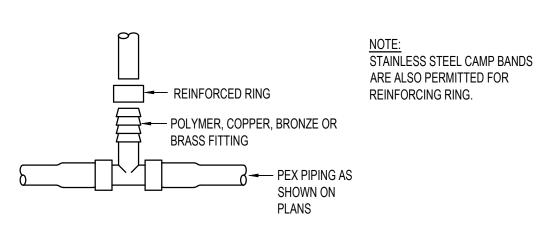


PEX PIPE FITTING DETAILS NO SCALE

DO NOT USE IN ANY APPLICATION WHERE TUBING WILL BE EXPOSED TO DIRECT SUNLIGHT. PEX PIPE INSTALLATION DETAILS NO SCALE

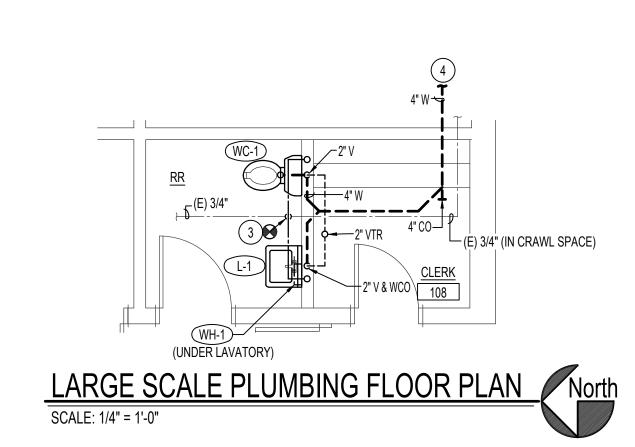

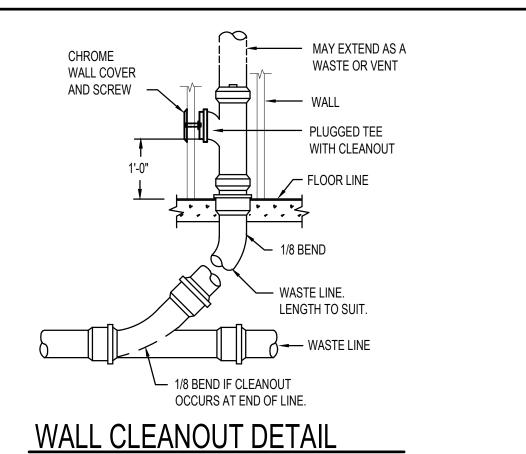

# NO SCALE

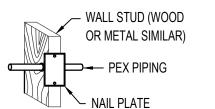

VERTICAL TUBING TO BE SUPPORTED EVERY 8'-0" WHEN PENETRATING METAL STUDS, UTILIZE A BUSHING DESIGNED FOR PLASTIC TUBING.


- METAL STUD


APPROVED

SUPPORTS SHALL BE INSTALLED AT CHANGES IN DIRECTION TO RELIEVE STRESS AS SHOWN.


#### WALL INSTALLATION

PIPE SUPPORTS: PLASTIC HANGERS AND STRAPS ARE RECOMMENDED, BUT METAL SUPPORTS WHICH ARE DESIGNED FOR USE WITH PLASTIC TUBING CAN BE

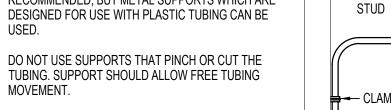

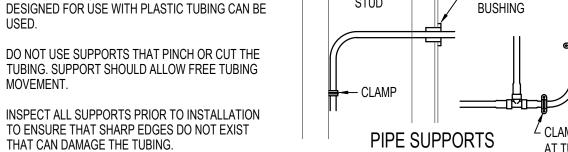


→ WOOD

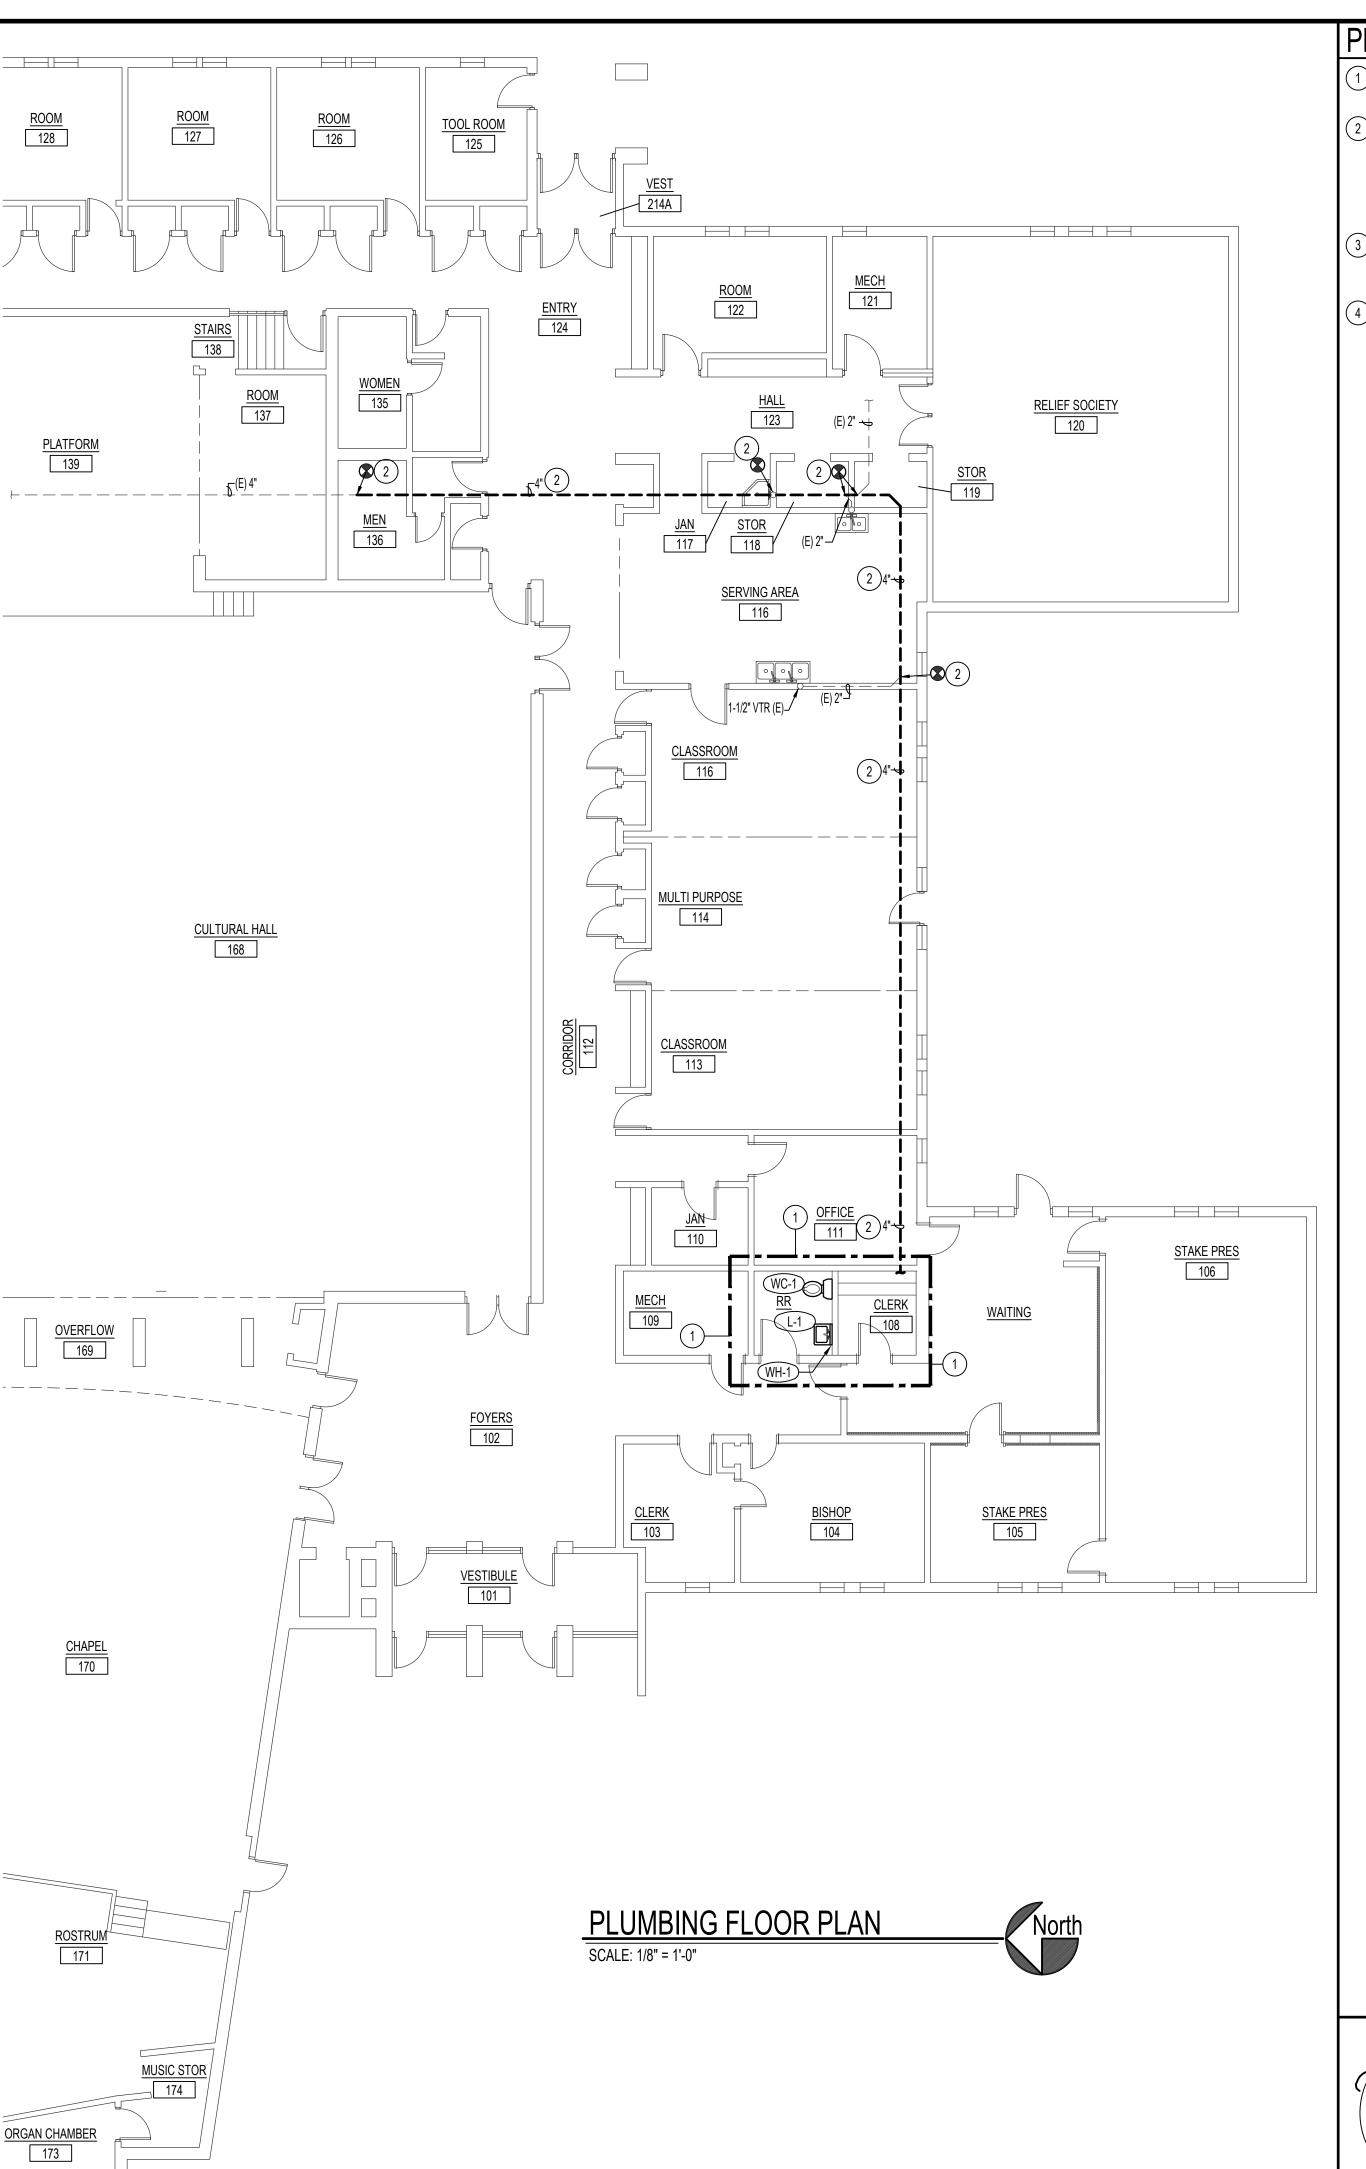



- 1) SEE LARGE SCALE PLUMBING PLAN ON THIS SHEET FOR WORK IN THIS AREA.
- P. ) REMOVE EXISTING 2" WASTE LINE IN TUNNEL BELOW AND REPLACE WITH 4" WASTE AND SLOPE AT 1/4" PER FOOT. DISCONNECT EXISTING BRANCH WASTE LINES AND RECONNECT TO NEW PIPING. COORDINATE WITH GENERAL CONTRACTOR FOR REQUIRED SAW CUTTING OF FLOOR. FIELD VERIFY EXISTING CONDITIONS.
- 3 ) CONNECT TO EXISTING COLD WATER LINE IN CRAWL SPACE BELOW AND RISE UP IN WALL TO SERVE FIXTURES. FIELD VERIFY EXISTING CONDITIONS.
- ig(f4ig) SEE PLUMBING PLAN ON THIS SHEET FOR CONTINUATION.

HURCH OF
CHRIST
R-DAY SAINTS JESUS COF LATTER-1

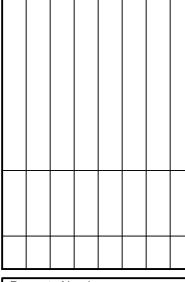

Property Number 513-0220 Plan Series:

2025. 04.03 Sheet Title:

> MAIN PLUMBING FLOOR PLAN,

SCHEDULES &

**DETAILS** 

Engineered **Systems Associates** 1355 EAST CENTER POCATELLO, IDAHO 83201






	ECTRICAL SYMBOL SCHEDULE	$\cup$	DATA/COMM. SYMBOL SCHEDU			
	LIGHTING FIXTURE	_T-X <b>•</b>	TELEPHONE OUTLET ( _=# OF CABLES, X=CONDUIT SIZE SEE BELOV			
	EMERG. FIXTURE WITH EMERG. BATTERY PACK, CONNECTED TO UNSWITCHED LEG OF LIGHTING CIRCUIT.	_D-X <b>•</b>	DATA OUTLET ( _=# OF CABLES, X=CONDUIT SIZE SEE BELOW)			
F#E	NIGHT LIGHT FIXTURE, CONNECTED FIXTURE TO UNSWITCHED LEG OF	_T/_D-X ►	TELE/DATA OUTLET ( _=# OF CABLES, X=CONDUIT SIZE SEE BELOW			
NL	LIGHTING CIRCUIT.	_D <b></b>	DATA OUTLET - ABOVE CEILING ( _=# OF CABLES)			
$\otimes \otimes$	EXIT SIGN, WALL OR CEILING MOUNT & DIRECTIONAL ARROWS AS INDICATED ON DRAWINGS. CONNECT TO UNSWITCHED LEG OF		TELEPHONE & DATA OUTLET NOTES:			
	NEAREST LIGHTING CIRCUIT.		1. UTILIZE 4 11/16" DEEP BOX WITH REQUIRED MUDRING AND CON TO COMMUNICATIONS BOARD, TERMINATE WITH INSULATED TH			
0	CEILING MOUNTED FIXTURE	-	BUSHING. PROVIDE QTY OF CABLES INDICATED FROM OUTLET TO NEAREST TELE/DATA ROOM. SEE DWGS FOR ADDITIONAL			
<u>Ю</u>	WALL MOUNTED FIXTURE	4	INFORMATION. PROVIDE J-HOOKS 3FT ON CENTER ABOVE ACCESSIBLE CEILING FOR SUPPORT OF CABLING.			
	RECESSED CAN FIXTURE	4	2. CONDUIT SIZES (X): 2=1/2", 3=3/4" , 4=1", 5=(2) 1"			
S S	EMERGENCY WALL LIGHT WITH 90MIN. BATTERY  TRAC LIGHT SYSTEM	-	3. NO LABEL INDICATES: 4 11/16" DEEP BOX WITH 1-GANG MUDRIN			
<u> </u>	SINGLE POLE SWITCH (SEE SUBSCRIPTS)	1	AND 1" CONDUIT TO ABOVE NEAREST ACCESSIBLE CEILING/CAI TRAY. TERMINATE WITH INSULATED THROATBUSHING (UNO).			
<u> </u>	DUAL-LEVEL SWITCH (SEE SUBSCRIPTS)  DUAL-LEVEL SWITCHES; IN-BOARD AND OUT-BOARD LAMPS SHALL BE	1	PROVIDE WITH PULL STRING.			
<u>\$\$</u>	SWITCHED SEPARATELY. (SUBSCRIPT APPLIES TO BOTH SWITCHES)		LARGE CAPACITY BOX (C = CEILING MOUNTED)			
	3 = 3-WAY 4 = 4-WAY		LARGE CAPACITY 2 GANG J-BOX (HUBBELL HBL260) WITH 2 GAN			
SWITCH SUB-	F = EXHAUST FAN TIMER (INTERMATIC MODEL EI400 SERIES) T = THERMAL OVERLOAD SWITCH W/PILOT LIGHT	◉	MUDRING AND VANCO 2GANG CABLE EXIT BRUSH WALL PLATE 12082). INSTALL A 2" CONDUIT TO ABOVE ACCESSIBLE CEILING			
SCRIPTS	P = 1-POLE SWITCH WITH PILOT LIGHT. (SEE SPECS)		TO A CEILING MOUNTED BOX IN HARD CEILING APPLICATION.			
	M = SWITCH SUPPLIED W/ EQUIPMENT (INSTALLED BY E.C.) WP = WEATHERPROOF					
	WALL BOX DIMMER SWITCH. (SWITCH TO BE COMPAT. W/LOAD SERVED)		IICATIONS CABLING REQUIREMENTS:			
\$	LED 0-10V: LEVITON RENOIR II #AWSMG-7D* W/MATCHING WALL PLATE OR EQUAL (* COLOR TO MATCH WIRING DEVICES)		CIFICATIONS FOR ADDITIONAL INFORMATION) K CABLING - CAT6 PLENUM RATED, BLUE			
	SWITCH MOUNTED OCCUDANCY SENSOR LINE VOLTAGE	TELEPHONE CABLING - CAT6 PLENUM RATED, YELLOW TELEVISION CABLING - COAXIAL, RG-6				
D	SWITCH MOUNTED OCCUPANCY SENSOR, LINE VOLTAGE, W/ COVERPLATE, (COLOR TO MATCH WIRING DEVICES)	ICLEVIOL	ON ONDEHNO - OUANIAE, NO-U			
<b>\$</b> P	P = PASSIVE INFRARED,1-POLE [WATTSTOPPER # PW-301] P2 = PASSIVE INFRARED,2-POLE [WATTSTOPPER # PW-302]	GEN	ERAL NOTES: (ALL SHEETS)			
	D = DUAL TECHNOLOGY,1-POLE [WATTSTOPPER # DSW-100] D2 = DUAL TECHNOLOGY,2-POLE [WATTSTOPPER # DSW-200]					
			CTRICAL CONTRACTOR SHALL COORDINATE ALL LAMP TYPES WI			
	CEILING MOUNTED OCCUPANCY SENSOR  BLANK = DUAL TECH., LINE VOLTAGE [WATTSTOPPER #DT-355]		URE TYPE BEFORE ORDERING.			
<b>(S)</b>	L = LARGE AREA, ULTRASONIC LOW VOLTAGE [WATTSTOPPER #WT-2205] H = HALLWAY, ULTRASONIC LOW VOLTAGE [WATTSTOPPER #WT-2255]		CTRICAL CONTRACTOR SHALL REFER TO THE MECHANICAL WINGS FOR EXACT LOCATION OF ALL MECHANICAL EQUIPMENT A			
	R = RESTROOM, DUAL TECH., LINE VOLTAGE, 2-POLE		CTRICAL CONNECTIONS.			
	[SENSOR SWITCH #CMR-PDT-9-2P], (1) RELAY FOR LTG, (1) RELAY FOR EXHAUST FAN (30 MIN. DELAY)	C. ELEC	CTRICAL CONTRACTOR SHALL PROVIDE MINIMUM WORKING			
	D = INTEGRAL DAYLIGHT SENSOR TO AUTOMATICALLY CONTROL FIXTURES IN DAYLIGHT ZONES	CLE	ARANCE AS PER NEC BEFORE INSTALLING ANY ELECTRICAL PAN			
	W = WALL MOUNTED ON/OFF/DIM W2= WALL MOUNTED OCC SENSOR ON/OFF ONLY	FUR	CABINETS.			
	*PROVIDE LOW VOLTAGE SENSORS WITH POWER/RELAY PACK(S) AS		ALL ALL LIGHT FIXTURES IN MECHANICAL ROOM AFTER THE CHANICAL EQUIPMENT IS IN PLACE, ADJUST AS NECESSARY.			
<u> </u>	REQUIRED FOR OPERATION. [WATTSTOPPER #BZ-50]		VIDE CHAIN SUSPENSION KITS AS REQUIRED.			
<u>E</u>	PHOTOELECTRIC CELL/SWITCH	E. REFI	ER TO ARCHITECTURAL REFLECTED CEILING PLAN FOR EXACT			
	TIME CLOCK SWITCH		URE LOCATIONS, CEILING TYPES, ETC.			
•	PUSHBUTTON (AS INDICATED ON DRAWINGS)	F. ELEC	CTRICAL CONTRACTOR SHALL PROVIDE ALL CONCRETE PADS AS			
Φ	DUPLEX RECEPTACLE	REQ	UIRED ON ALL ELECTRICAL EQUIPMENT.			
Φ	BOTTOM HALF OF RECEPTACLE SHALL BE SWITCHED	-1	IFIRM EXACT LOCATIONS OF ALL TELEPHONE / DATA OUTLETS W			
<del></del>	DOUBLE DUPLEX OUTLET (4-PLEX)	OWN	NER PRIOR TO ROUGH - IN.			
<del>"</del>	CEILING MOUNTED DUPLEX RECEPTACLE		CTRICAL CONTRACTOR SHALL MOUNT SWITCHES AT 48" AND MO			
RECPT.	AC=ABOVE COUNTER USB=RECEPTACLE W/USB CHARGER		IVENIENCE OUTLETS AT 18" OR AS SHOWN ON PLANS TO MEET DICAPPED REQUIREMENTS.			
SUB-	GFI=GROUND-FAULT CR=CORD REEL (SEE DETAIL) IG=ISOLATED GROUND	I. LOC	ATE SWITCHES, OUTLETS, ETC., SHOWN AT ROOM ENTRY			
SCRIPTS	S=SURGE SUPPRESSION	DOO	RWAYS, AS CLOSE TO DOOR FRAME AS POSSIBLE, SO AS NOT TO			
	TR=UL TAMPER RESISTANT WP=WEATHERPROOF COVER W/GFCI RECEPT.		ERFERE WITH ROOM CABINETS, ETC.			
•W	TV= RECPT. FOR TV, SEE ARCH. ELEVATION DWGS FOR MTG. HEIGHT	J. SUP	PORT ALL LIGHT FIXTURES INDEPENDENT OF CEILING.			
	50A 208V 1Ø WELDER OUTLET		CTRICAL CONTRACTOR SHALL OBTAIN ALL APPLICABLE PERMITS S WORK AND PAY ASSOCIATED FEES.			
lacktriangle	FLOORBOX - POWER ONLY (1-DUPLEX RECEPTACLE) SUCH AS					
LY	HUBBELL CFB2G30/24GCCVRALU/FBNPDUP/FBNPBNK1/HBL8300GRY		NTAIN 24" MIN. CLEARANCE FROM ALL COMMUNICATIONS CABLES DELECTRONIC BALLASTS.			
/MI=	MULTI PURPOSE SCRUBWATER FLOOR BOX. FSR #FL200-4-CSK-S45MM-BKT-FL200-SCU-CBA					
	WITH DUPLEX RECEPTACLE. E.C. SHALL COORDINATE WITH FLOOR TYPE. INSTALL (2) 2" CONDUITS TO ABOVE CEILING WITH PULL CORD FOR IT AND AV		BATTERY EXIT AND EMERGENCY LIGHTING TO BE CONNECTED TUNSWITCHED LEG OF THE LIGHTING CIRCUIT IN THE AREA AS PE			
	DISCONNECT SWITCH (SIZE AND TYPE AS INDICATED)	COD	DE.			
	F=FUSED DISCONNECT (FUSE PER EQUIP. NAMEPLATE) B=ENCLOSED CIRCUIT BREAKER		ESS SPECIFICALLY INDICATED OTHERWISE, THE ELECTRICAL			
	V=VFD (PROVIDED BY M.C. CONNECTED AND INSTALLED BY E.C.)		ITRACTOR TO COORDINATE WITH ANY SPECIAL SYSTEMS SUPPLI NTR., EX. DENTAL, MEDICAL, KITCHEN,EQUIPMENT ETC. THE EXAC			
_	COMPANY SWITCH WITH DISCONNECT, PIN & SLEEVE OUTLET; HUBBELL #HBL460MRW W/ HBL460P12W PLUG. SUPPLY WITH ERICSON	ROU	IGH-IN REQUIREMENTS FOR THERE EQUIPMENT. ALSO UNLESS CATED OTHERWISE, THE ELECTRICAL CONTR. TO BE RESPONSIB			
CS	0S2E-01-060PCLB SPIDER BOX W/ 12 GFI RECEPTACLES. SUPPLY W/		FINAL CONNECTIONS TO ALL SPECIAL EQUIPMENT.			
	50FT. 4-#6 + GROUND CABLE W/ MATCHING PLUG AT SPDER BOX.	O. ALL	CONDUIT /RACEWAY /CABLES, TO BE CONCEALED IN WALLS OR			
	COMBINATION STARTER & FUSED DISCONNECT SWITCH; 2-SETS OF NO/NC CONTACTS, CONTROL XFMR, FUSE PER EQUIP. NAMEPLATE	ABO	IVE CEILINGS. IF ANY SURFACE WORK IS NECESSARY, IT SHALL B ROVED BY THE ARCHITECT /ENGINEER PRIOR TO DOING ANY WO			
	MAIN/DISTRIBUTION PANELBOARD					
<u> </u>	BRANCH PANELBOARD		SHALL VISIT THE SITE PRIOR TO BID AND THOROUGHLY STIGATE THE EXISTING CONDITIONS, AS THEY RELATE TO THE			
	TELEPHONE / DATA BOARD (GRND AS PER UTIL. CO)	sco	PE OF WORK DESCRIBED. MAKE NECESSARY PROVISIONS IN THI			
	BRANCH CIRCUIT - CONCEALED	BAS	E BID TO ADEQUATELY ACCOMMODATE THESE CONDITIONS.			
	BRANCH CIRCUIT - IN FLOOR OR UNDERGROUND		CTION BOXES FOR LIGHTING CIRCUITING ARE NOT SHOWN FOR RITY. THE E.C. IS RESPONSIBLE FOR PROVIDING AND INSTALLING			
A-1,3		JUN	CTION BOXES REQUIRED FOR CIRCUITING OF ALL LIGHT FIXTURE			
1	DRAWING NOTE (ON THE SHEET WHERE SHOWN)	1 THA	T ARE NOT LISTED FOR "THROUGH-BRANCH CIRCUIT WIRING".			
<b>T</b>	MECHANICAL EQUIPMENT OR DETAIL SYMBOL	]				
J	JUNCTION BOX	]				
T	THERMOSTAT W/ 3/4"CONDUIT W/PULL CORD TO MECH. UNIT *	]				
S	HVAC SYSTEM SENSOR - SEE MECHANICAL *	]				
	CROSS LINES SHOW # OF PHASE/NEUTRAL CONDUCTORS IF MORE THAN	1				
<del> II</del>	TWO. EQUIPMENT/ISOLATED GROUNDING CONDUCTORS ARE NOT SHOWN. PROVIDE 'GREEN' EQUIP. GROUNDING CONDUCTOR FOR ALL					
	CIRCUITS AND ADDITIONAL ISOLATED GROUND WHERE INDICATED.	]				
Ē	FAN MOTOR CONNECTION POINT	]				
<u> </u>	MOTOR CONNECTION POINT	]				
A.F.F.	ABOVE FINISHED FLOOR	]				
B.F.G.	BELOW FINISHED GRADE	]				
E.C.	ELECTRICAL CONTRACTOR	]				
G.C.	GENERAL CONTRACTOR	]				
M.C.	MECHANICAL CONTRACTOR					
NL	NIGHT LIGHT (CONNECT TO UNSWITCHED LEG OF LTG CIRCUIT)	j				
		1				


V.I.F. VERIFY IN FIELD

ROUGH-IN BOX MUD RING ORIENTATION.

SEE MECHANICAL DRAWINGS FOR CONDUIT DESTINATION AND

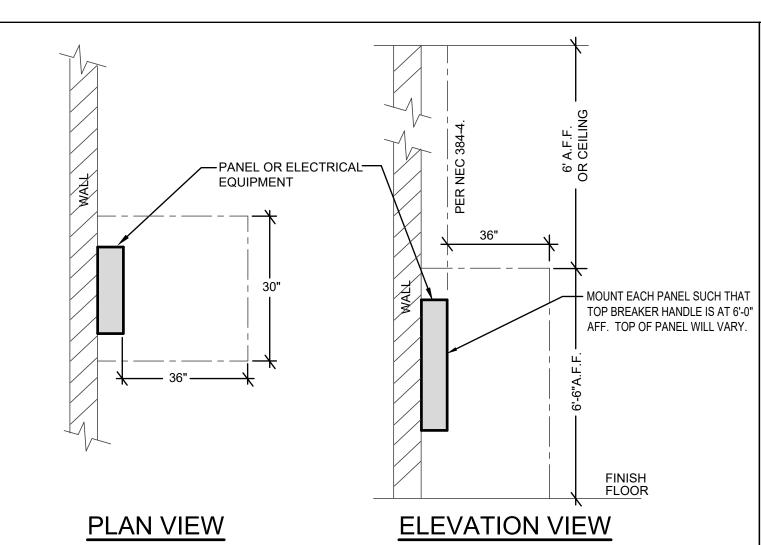

## ELECTRICAL EQUIP. CLEARANCE DETAIL

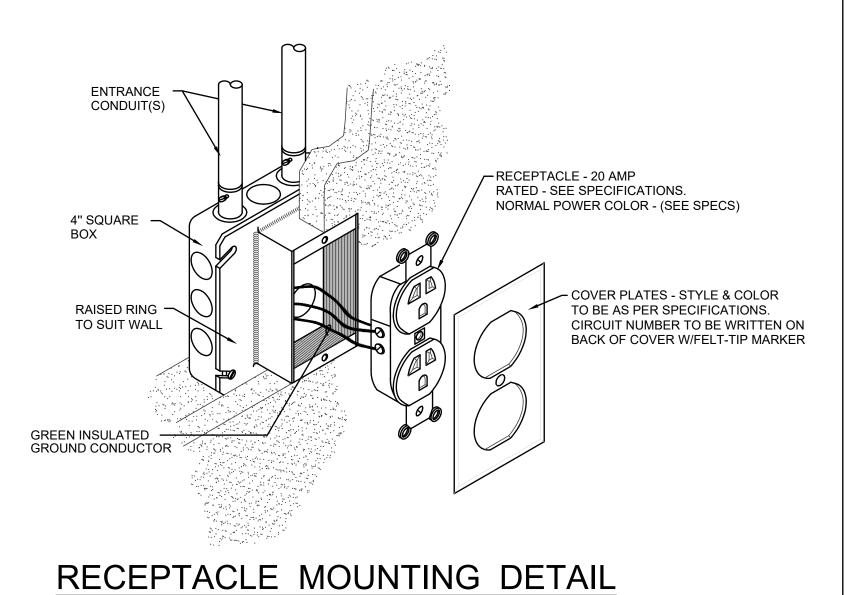

NO SCALE

THERMOSTAT OR MECHANICAL SWITCH -VERIFY WITH MECH. LIGHT SWITCH MUD RING ORIENTATION. CONVENIENCE OUTLET TELEPHONE / DATA OUTLET -@ MILLWORK T.V. OUTLET A. ALL MOUNTING HEIGHTS TYPICAL UNLESS NOTED OTHERWISE. B. COORDINATE OUTLET HEIGHTS WITH ARCHITECTS MILLWORK DWGS. TO 5' - 0" INSURE THAT OUTLETS WILL NOT FALL BEHIND CABINETS, BACKSPLASHES, OR INTERFERE WITH WAINSCOTING, ETC. (OR AS NOTED) D. ALL SWITCHES AND THERMOSTATS TO BE MOUNTED AS CLOSE TO DOOR JAMBS AS POSSIBLE. COORDINATE ALL DEVICES WITH ARCHITECTURAL PLANS AND DETAILS. \* COORDINATE LIGHT SWITCH & OUTLET (OR AS NOTED) HEIGHTS WITH ARCHITECTURAL WAINS-COTING AND OR TILE WORK SO AS NOT TO FALL MIDWAY IN THESE FINISHES. FINISHED FLOOR TYPICAL DEVICE MOUNTING HEIGHTS DIAGRAM

> ORIGINAL SIGNED BY: TODD E. PAYNE DATED ORIGINAL SIGNED: 4-4-2025 ON FILE AT: PAYNE ENGINEERING INC

P.E. JOB #2541 *IPAYNE* Engineering Inc. 1823 E. Center Pocatello, Idaho 83201 tel (208) 232-4439

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Plan Series:

Sheet Title:

Electrical Details


 $\forall$ 

JAMES K.

NO SCALE


#### EXISTING ELECTRICAL KEY NOTES

- DISCONNECT AND REMOVE EXISTING DEVICE IN CONFLICT WITH REMODEL. REMOVE ALL ASSOCIATED CONDUIT AND WIRE BACK TO NEXT ACTIVE BOX OR SOURCE. RESTORE ELECTRICAL CONTINUITY TO EXISTING DEVICES TO REMAIN.
- 2 REPLACE EXISTING DEVICE WITH NEW DEVICE AND COVER PLATE.
- 3 DISCONNECT AND REMOVE EXISTING FIXTURE. MAINTAIN POWER AND CONTROLS FOR NEW
- disconnect and remove existing light fixture and all associated conduit and controls. Maintain circuit for New Lighting and controls.
- 5 CAREFULLY REMOVE EXISTING SPEAKER AND REINSTALL AFTER NEW TILE IS INSTALLED.
- 6 EXISTING EXIT SIGN TO REMAIN. REMOVE EXISTING SURFACE MOUNTED CONDUIT AND CONNECT EXIT SIGN TO UNSWITCHED LEG OF LIGHTING CIRCUIT.
- 7 EXISTING DEVICE TO REMAIN. PROTECT DURING CONSTRUCTION.

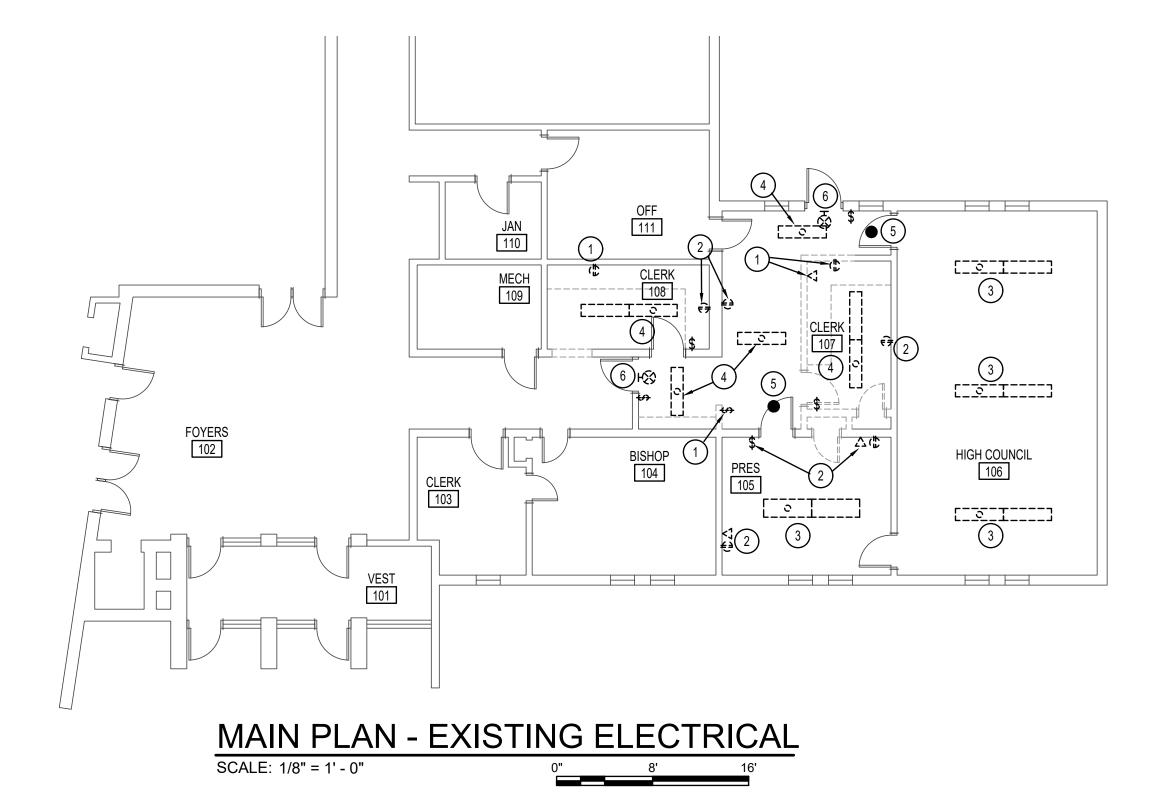

#### **ELECTRICAL KEY NOTES**

- 1) CONNECT NEW FIXTURE TO EXISTING LIGHTING CIRCUIT AND CONTROLS.
- 2 CONNECT NEW FIXTURE TO EXISTING LIGHTING CIRCUIT. PROVIDE NEW CONTROLS AS SHOWN.
- (3) CONNECT TO EXISTING RECEPTACLE CIRCUIT.
- PROVIDE AND INSTALL A DATA CONNECTION AT THIS LOCATION. UTILIZE EXISTING CABLING IF POSSIBLE. EC SHALL COORDINATE LOCATION AND REQUIREMENTS WITH LOCAL FM.
- 5 EC SHALL PROVIDE AND INSTALL A NEW 20A 120V CIRCUIT TO NEW WATER HEATER. CONNECT TO NEAREST SPARE 20A BREAKER. EC SHALL FIELD VERIFY PRIOR TO BIDDING.

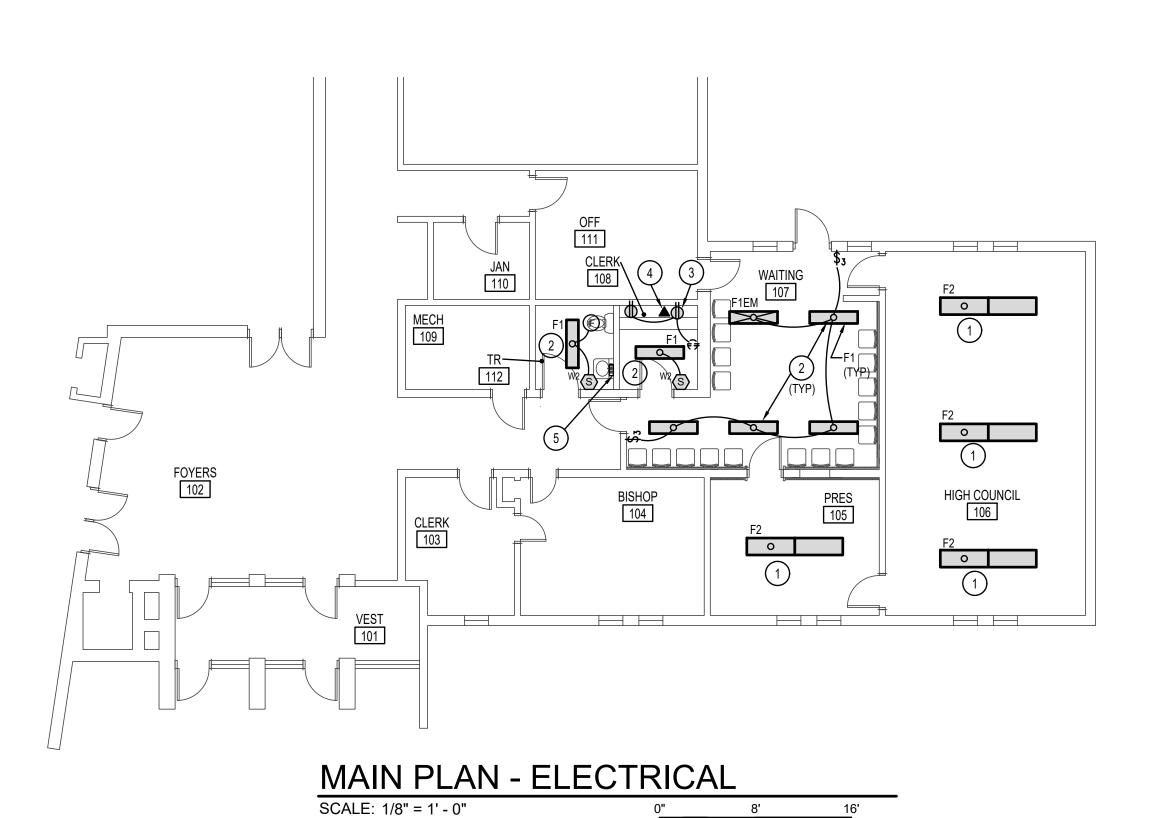

		LIGI	НТ	FIXTURE	SCHEDULE 1., 2.			
TYPE	DESCRIPTION	MOUNT	VOLT	LAMPS	MFGR.	CATALOG #	NOTES	
F1	4 FT LED WRAP NARROW BODY	CEILING	120/277	INCLUDED	LITHONIA	LBL4 4800LM 80CRI 35K NODIM MVOLT NO SUBSTITUTION, MATCHING EXISTING		
F2	4 FT LED WRAP WIDE BODY	CEILING	120/277	INCLUDED	LITHONIA	LBL4W 6500LM 80CRI 35K NODIM MVOLT NO SUBSTITUTION, MATCHING EXISTING		

#### FIXTURE NOTES:

- 1. THE SUFFIX "EM" DENOTES A FIXTURE SUPPLIED WITH AN EMERGENCY BATTERY BALLAST.
- WIRE SUCH THAT UNDER NORMAL POWER CONDITIONS THE FIXTURE WILL OPERATE WITH THE INDICATED SWITCHING, UPON LOSS OF UTILITY WILL TRANSFER TO BATTERY.
- 2. ALL BATTERY FIXTURES ARE TO BE CONNECTED TO THE UNSWITCHED LEG OF LIGHTING CIRCUIT FEEDING THE AREA.





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E-2.0

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Plan Series:

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Electrical Floor Plans