

DFCM SOLICITATION ADDENDUM COVER PAGE

DFCM Addendum No.1

Date: July 20, 2023

To: Bidding Contractors

From: Carl Francis-DFCM Project Manager

Reference: Main Campus Meat Lab Freezer Floor Repairs

DFCM Project 23462210

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Note: This Addendum shall be included as part of the Contract Documents. Items in this Addendum apply to all drawings and specification sections whether referenced or not involving the portion of the work added, deleted, modified, or otherwise addressed in the Addendum. Acknowledge receipt of this Addendum in the space provided on the Bid Form. Failure to do so may subject the Bidder to Disqualification.

1.1 Schedule Changes: There are no project schedule changes within this Addendum No .1

1.2 General Items: AD1.0.1 G-001 COVER SHEET & PROJECT INFORMATION

1. Added vicinity map

1.3 Architectural: AD1.0.2 A-101 FLOOR PLAN, DEMOLITION PLAN & DETAILS

1. Clarified floor components

a. PSI strength for concrete added

b. Specified tile to be installed with pattern layout

c. Added epoxy grout requirement

d. Added Welded Wire Fabric Mesh requirement to notes including size and placement.

e. Adjusted conduit sizing to 1" from ¾" to align with electrical

requirement.

f. Specified MIL thickness of vapor barrier.

1.4 Electrical: None

1.5 Attachments: G-001 COVER SHEET & PROJECT INFORMATION

A-101 FLOOR PLAN, DEMOLITION PLAN & DETAILS



date: 6/15/2023

project:

BTech Meat Services Freezer Floor Replacement

Stephen Williams

subject: Addendum 1

CONTRACT ADDENDUM #1

The Work shall be carried out in accordance with the following supplemental instructions issued in accordance with the Contract Documents. Prior to proceeding in accordance with these instructions, indicate your acceptance of these instructions for minor change to the work as consistent with the Contract Documents and return a copy to the Architect.

Items

General

AD1.0.1 G-001 COVER SHEET & PROJECT INFORMATION

1. Added vicinity map

Architectural

AD1.0.2 A-101 FLOOR PLAN, DEMOLITION PLAN & DETAILS

- 1. Clarified floor components
 - a. PSI strength for concrete added
 - b. Specified tile to be installed with pattern layout
 - c. Added epoxy grout requirement
 - d. Added Welded Wire Fabric Mesh requirement to notes including size and placement.
 - e. Adjusted conduit sizing to 1" from 3/4" to align with electrical requirement.
 - Specified MIL thickness of vapor barrier.

Electrical

None

Attachments

G-001 **COVER SHEET & PROJECT INFORMATION** A-101 FLOOR PLAN, DEMOLITION PLAN & DETAILS

Stephen M. Williams, AIA NCARB

ISSUED BY Architect

Date

ACCEPTED BY Contractor

Date

PHONE: 435.753.6780

CAPITAL HILL COMPLEX, 450 STATE ST SUITE 4110 SALT LAKE CITY, UT 84114 PHONE: 801.538.3018 jcfrancis@utah.gov CARL FRANCIS

ARCHITECT

ELECTRICAL

DESIGN WEST ARCHITECTS 255 S 300 W LOGAN, UT 84321 PHONE: 435.752.7031 stephenw@designwestarchitects.com STEPHEN WILLIAMS

SINE SOURCE ENGINEERING 95 GOLF COURSE RD LOGAN, UT 84321 PHONE: 435.787.1445 ericr@sinesource.net ERIC RASMUSSEN

ABBREVIATIONS

DESCRIPTION DESCRIPTION DESCRIPTION <u>ABR.</u> ANCHOR BOLT **EXIST** EXISTING PART BD PARTICLE BOARD EXP **EXPANSION** ACRYLONITRILE-BUTADIENE PART'N **PARTITION EXTERIOR** P-LAM PLASTIC LAMINATE PLATE ACOUSTIC, ACOUSTICAL FLOOR DRAIN PLYWD PLYW00D ACCESSIBLE STATION FDN FOUNDATION PREFAB PREFABRICATED ADDENDUM FIRE EXTINGUISHER CABINET PROJECTION **ADJUSTABLE** PRESERVATIVE TREATED FINISH FLR ABOVE FINISH FLOOR FL00R POLYVINYL CHLORIDE ALT ALTERNATE **FOOTING** QUARRY TILE ALUM ALUMINUM GAUGE ROUND ARCHITECT SUPPLEMENTAL GALV GALVANIZED RADIUS INSTRUCTION GALVANIZED IRON **ROOF DRAIN** REF ASPHALT GYP BD GYPSUM BOARD REFRIGERATOR HDWD REINF REINFORCE HARDW00D BASKETBALL REV HOLLOW METAL REVISION BOARD HORIZONTAL REQUEST FOR INFORMATION BUILDING HEIGHT ROUGH OPENING BLOCKING **INSIDE DIAMETER** SCHED SCHEDULE SHT SIM BENCH MARK INSULATION B.0. BOTTOM OF **INTERIOR** SIMILAR BRG BEARING SPECIFICATION JOINT **BASEMENT** KNOCK DOWN SQUARE B.U.R. **BUILT UP ROOF** KNOCK OUT SS STAINLESS STEEL STD CHANNEL ANGLE STANDARD STL CHALKBOARD LLV LONG LEG VERTICAL STEEL **CENTER LINE** STOR STORAGE MAXIMUM STRUCTURAL CLG CEILING MARKER BOARD STRUCT CMU CO CONCRETE MASONRY UNIT MECH MECHANICAL SUSP SUSPENDED, SUSPENSION CLEAN OUT SYS MANUFACTURER COL COLUMN MANHOLE T & B TOP AND BOTTOM CONC CONCRETE MINIMUM **TACKBOARD** CONNECTION MISCELLANEOUS **TEMPORARY** MASONRY OPENING CONT CONTINUOUS MO TEL TELEPHONE CONTR CONTRACTOR THRESHOLD MOUNT CT CERAMIC TILE MTL METAL TUBE STEEL T.0. PENNY NEW TOP OF DIM DIMENSION NOT IN CONTRACT T0IL TOILET NOT TO SCALE DS DOWNSPOUT NTS **TELEVISION** TYP DRAWING ON CENTER TYPICAL EXISTING OUTSIDE DIAMETER VERTICAL EACH UNLESS NOTED OTHERWISE OVERHEAD U.N.O. EXTERIOR INSULATION OF/CI EIFS OWNER FURNISHED / WIDE FLANGE FINISH SYSTEM CONTRACTOR INSTALLED ELECTRICAL OWNER FURNISHED / WATER CLOSET ELEV EQ OWNER INSTALLED WD ELEVATION WOOD WM WATER METER EQUAL OPENING

W/0

WWF

WITHOUT

WELDED WIRE FABRIC

0PP

0.T.S.

OPPOSITE

OPEN TO STRUCTURE

EQUIPMENT

ELECTRIC WATER COOLER

EWC

SHEET INDEX

DEFINED WITHIN SPECIFICATIONS AND/OR DRAWINGS.

BID OR BEFORE CONTINUING THAT PORTION OF WORK.

SCHEDULE - FINISH

SPECIFICATION

ELECTRICAL POWER PLAN

ARCHITECTURAL:

A-101

EE001 EE002

COVER SHEET - PROJECT INFORMATION

FLOOR PLAN, DEMOLITION PLAN & DETAILS

ABBREVIATIONS, G.P.N. LEGEND & SHEET INDEX

NOTE: THE CONSTRUCTION DOCUMENTS FOR THIS PROJECT ARE COMPOSED OF SETS OF DRAWINGS

AND SPECIFICATIONS, AND THEREFORE SHALL BE USED AND MAINTAINED IN THEIR ENTIRETY. ANY

ADDITIONALLY, DRAWINGS MAY NOT BE RE-SCALED WHEN PRINTED, WRITTEN DIMENSIONS SHALL

ANY DEVIATION FROM OR CONFLICT WITHIN THE DRAWINGS AND/OR SPECIFICATIONS, MUST BE

SUBMITTED VIA REQUEST FOR INFORMATION (RFI) AND RESPONDED TO BY THE ARCHITECT PRIOR TO

HAVE PRECEDENCE, AND LARGER SCALE DRAWINGS SHALL HAVE PRECEDENCE OVER SMALLER SCALE


CONTRACTOR, SUBCONTRACTOR, VENDOR OR PARTY PARTICIPATING IN OR BIDDING ON THIS PROJECT SHALL BE EXPECTED TO PERFORM DUE DILIGENCE TO ENSURE THEIR BID. WORK PERFORMED. AND MATERIALS PROVIDED CONFORMS TO THE INFORMATION PROVIDED WITHIN ANY AND ALL SHEETS OF DRAWINGS AND SPECIFICATIONS, INCLUDING, BUT NOT LIMITED TO, ANY SUBSEQUENT ADDENDA OR CLARIFICATIONS THAT MAY BE ISSUED RELEVANT TO THEIR SCOPE OF WORK. PROJECT SCOPE MAY BE

MATERIALS LEGEND SYMBOLS LEGEND **DESCRIPTION** <u>SYMBOL</u> **DESCRIPTION** <u>SYMBOL</u> BUILDING SECTION — A-101 DRAWING TAG — 1/8" = 1'-0" SUB DESCRIPTION WINDOW TYPES — STOREFRONT/ **CURTAIN WALL** DOOR TAG -SECTION DETAIL ENLARGED PLAN HARDWARE # `____ KEYNOTES - DIVISION # ELEVATION LEVEL ——— REVISIONS -INTERIOR **EXTERIOR** ELEVATIONS — GRID BUBBLE -FINISH WOOD ROOM NAME ALUMINUM ROOM TAG EQUIPMENT TAG — 101 CF MF FLOOR — ROOM FINISH TAG — NORTH ARROW — NORTH DIRECTION IS INDICATED BY THE DIRECTION THE FILLED

<u>MATERIAL</u> <u>SYMBOL</u> EARTH ASPHALT PAVING COMPACTED GRANULAR FILL 4 4 4 4 4 CONCRETE CONCRETE MASONRY UNITS BRICK STEEL CONTINUOUS WOOD WOOD BLOCKING PLYWOOD / OSB PARTICLE BOARD INSULATION RIGID INSULATION GYPSUM BOARD GLU-LAMINATE BEAM GLASS

WOOD STUD WALL

ARROW IS POINTING

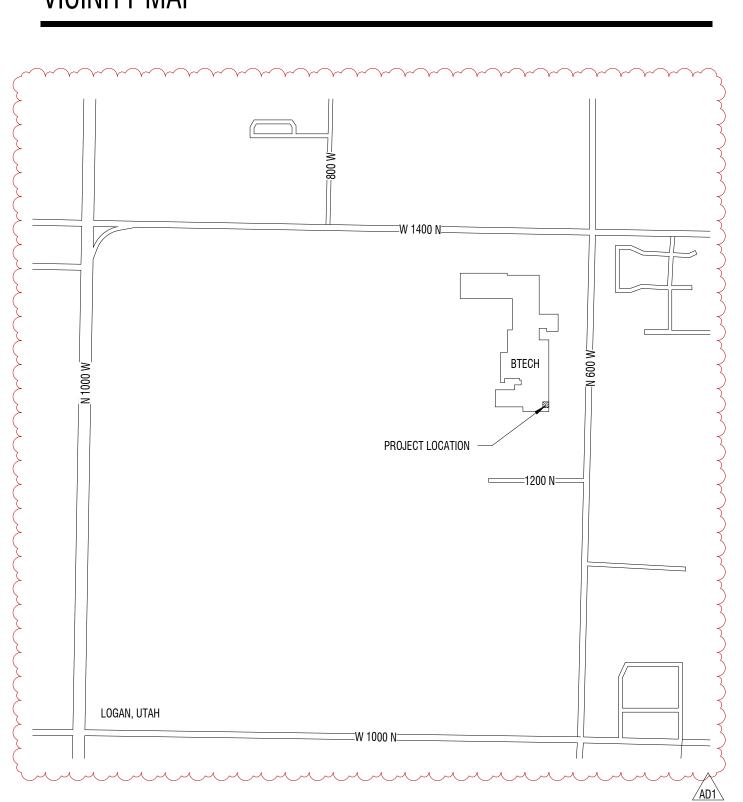

HASLAM WILLIAMS CHECKED BY: 06.09.2023

> **COVER SHEET -PROJECT INFORMATION**

VICINITY MAP

323202 PROJECT #:

architects

st |

esign

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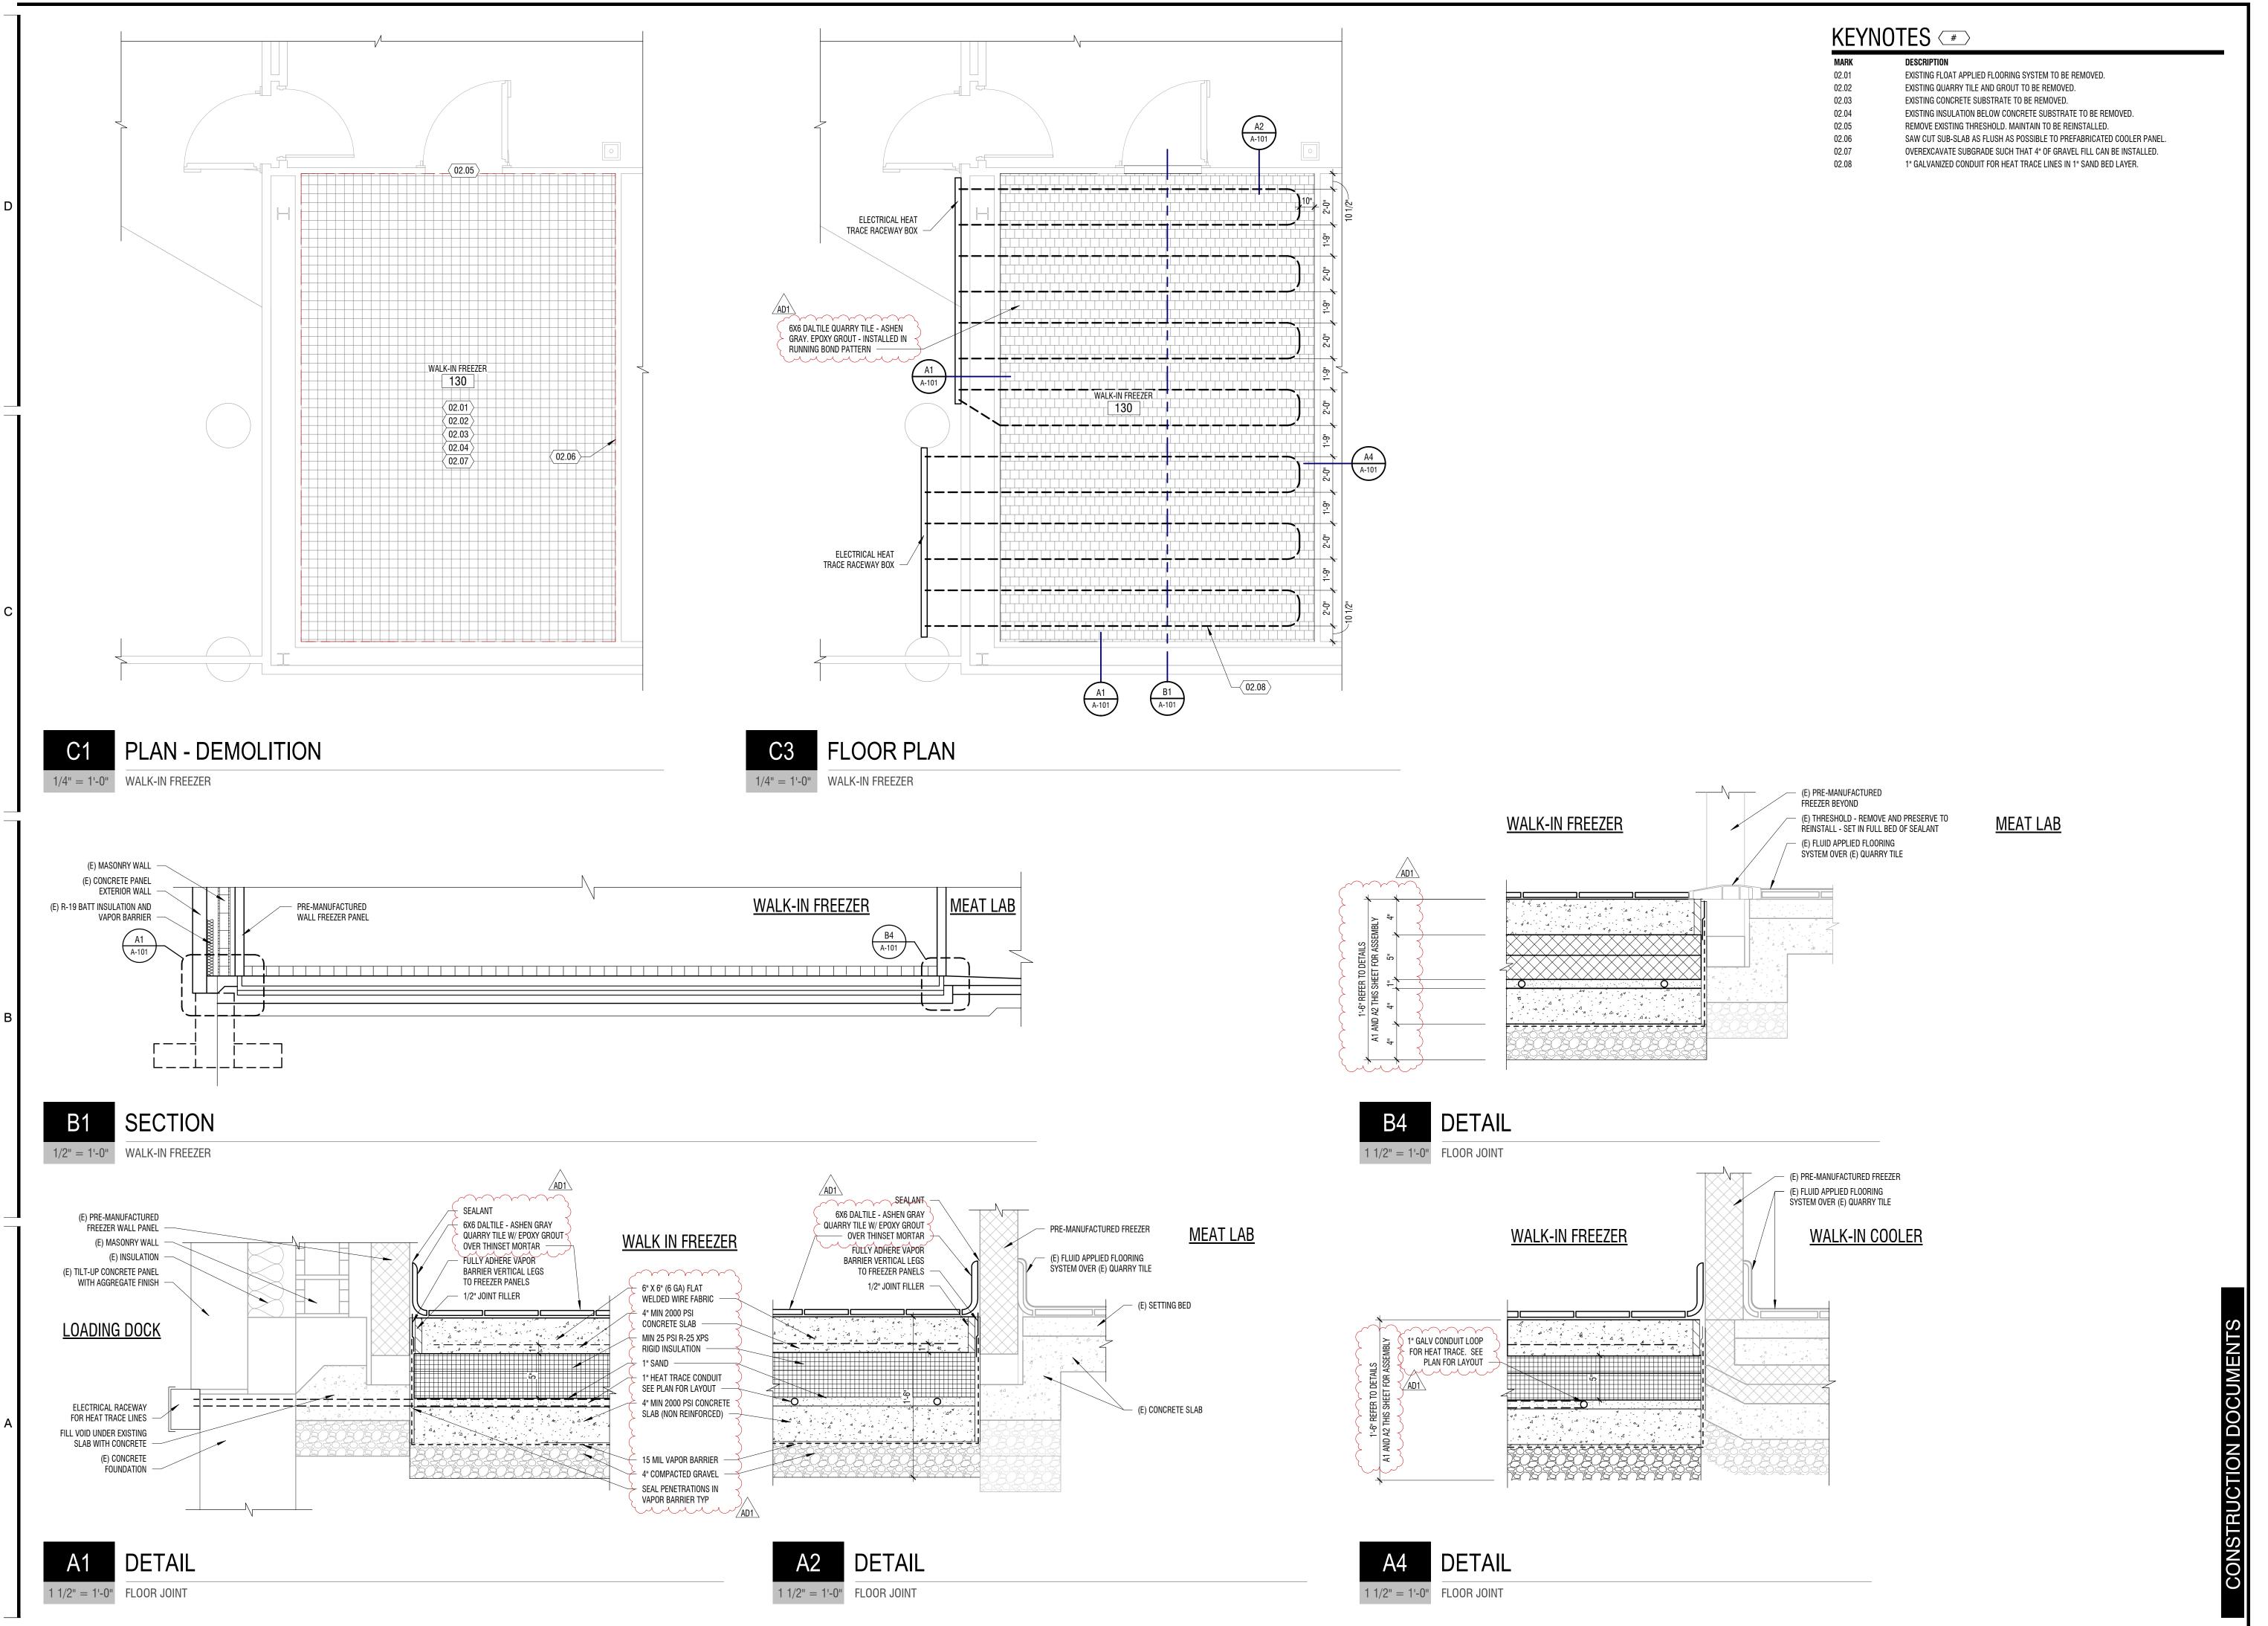
DFCM APPROVAL

RVICE

STECH MEAT SERVICE
REEZER FLOOR REPLACEMENT
301 N 600 W, LOGAN, UT 84321
SIDGERLAND TECHNICAL COLLEGE
FCM PROJECT #: 2346210

BTECH FREEZER F 1301 N 600 W, L BRIDGERLAND T DFCM PROJECT

G-001



design west architects
255 SOUTH 300 WEST SALLI AKE CITY UT 84321

DFCM APPROVAL

FCH MEAT SERVICES
EZER FLOOR REPLACEMENT

BRID BRID DFCN

1 6/14/2023 AD1

PROJECT #: 323202

DRAWN BY: HASLAM

CHECKED BY: WILLIAMS

ISSUED: 06.09.2023

STEPHEN M. WILLIAMS

9842808-0301

GTNSED ARCHITCH

FLOOR PLAN, DEMOLITION PLAN & DETAILS

A-101